D-1241 ROOF REPLACEMENT LEARNING CENTER (LC)

Mountain View, Ca 94040 P 650 941 1112

DIABLO VALLEY COLLEGE 321 GOLF CLUB ROAD PLEASANT HILL, CALIFORNIA

PREPARED FOR CONTRA COSTA COMMUNITY COLLEGE DISTRICT

SCOPE OF PROJECT

- REMOVE EXISTING BUILT-UP ROOFS AS SHOWN ON DRAWINGS.
- INSTALL NEW FLATSTOCK INSULATION, AS SHOWN ON THE DRAWINGS.
- INSTALL NEW SINGLE-PLY ROOF SYSTEM AS SHOWN ON THE DRAWINGS.

DRAWING NO TITLE

A1.0 TITLE SHEET, GENERAL NOTES, ABBREVIATIONS AND LEGEND

AD2.1 LEARNING CENTER ROOF DEMOLITION PLAN

A2.1 LEARNING CENTER ROOF PLAN ROOF REPLACEMENT DETAILS A10.50 A10.51 ROOF REPLACEMENT DETAILS

VICINITY MAP SITE MAP LOT 8 Shopping Center LC BUILDING -Baseball Field BASEBALL FIELD Middle School LOT 2 College Park High School ® VIKING DRIV SCOPE OF WORK

GENERAL NOTES

- (1) THE INFORMATION SHOWN ON THE DRAWINGS WAS COMPILED FROM VARIOUS SOURCES AND MAY NOT REFLECT THE ACTUAL CONDITIONS AT THE TIME OF CONSTRUCTION. THE CONTRACTOR SHALL VISIT THE
- SITE(S) AND VERIFY DIMENSIONS AND FIELD CONDITIONS PRIOR TO BID SUBMISSION. (2) THE CONTRACTOR SHALL BRING ANY DISCREPANCIES TO THE ATTENTION OF THE OWNER PRIOR TO BID
- REFER TO PROJECT SPECIFICATIONS FOR DETAILED REQUIREMENTS FOR MATERIAL AND WORKMANSHIP.
- ALL WORK SHALL CONFORM WITH LOCAL, STATE, AND FEDERAL REGULATIONS APPLICABLE TO THE PROJECT. (5) THE CONTRACTOR SHALL OBTAIN ALL NECESSARY PERMITS REQUIRED TO PERFORM THE WORK PRIOR TO THE
- THE CONTRACTOR SHALL MAKE SUBMITTALS AS REQUIRED BY THE PROJECT SPECIFICATIONS
- COMPONENTS SHOWN ON THE DRAWING SHALL BE NEW UNLESS INDICATED AS EXISTING (E).

- (13) THE CONTRACTOR SHALL PROVIDE ALL SHORING AND BRACING NECESSARY TO ENSURE THE STABILITY OF ANY AND ALL PARTS OF THE BUILDING CONSTRUCTION.

ROOF GENERAL NOTES

ABBREVIATIONS

- (1) REFER TO THE PROJECT MANUAL FOR WATERTIGHTNESS REQUIREMENTS AFTER DEMOLITION.
- (2) REFER TO THE ROOF TYPE DETAILS FOR ROOF SYSTEM COMPONENTS.

HEATING VENTILATION W/O

AIR CONDITIONING WT.

HVAC

- (3) REPORT UNSUITABLE SUBSTRATE CONDITIONS TO THE OWNER. DO NOT INSTALL ROOFING OVER UNSUITABLE
- (4) INSTALL CRICKETS ON THE UPSLOPE SIDE OF ALL PENETRATIONS GREATER THAN 2 FEET IN WIDTH. (5) RELOCATE (E) CONDUIT, I.E. ELECTRICAL, GAS, WATER, AND COMMUNICATIONS AS REQUIRED TO PERFORM

SYMBOLS

&	AND	I.D.	INSIDE DIAMETER				
L L	ANGLE	INT.	INTERIOR		DETAIL		
@	AT	JT.	JOINT				
G.		LT.	LIGHT JOINT		GRID LINE		
Ψ.	CENTERLINE				OND EINE		
Ø	DIAMETER/ROUND	MAX.	MAXIMUM	\bigcirc	REVISION		
# AC	POUND OR NUMBER	MEMB.	MEMBRANE		7 1/12/13/10/14		
AC	AIR CONDITIONING	MFR.	MANUFACTURER				
ACOUS.	ACOUSTICAL	MIN.	MINIMUM				
A.D.	AREA DRAIN	MIR.	MIRROR				
ADJ.	ADJUSTABLE	MISC.	MISCELLANEOUS	LEGEND			
AL.	ALUMINUM	MTL.	METAL				
APPROX.	APPROXIMATE	MUL.	MULLION		ROOF EDGE	- 5-⊠	SUMP WITH DRAINS
ARCH.	ARCHITECTURAL	(N)	NEW		- ROOF EDGE	112	SUMF WITH DRAINS
BD.	BOARD	Ň	NORTH		GUTTER WITH	1	DD AIN
BLDG.	BUILDING	N.I.C.	NOT IN CONTRACT		DOWNSPOUT	-γ-	DRAIN
BLK.	BLOCK	NO. OR #	NUMBER		DOWNSPOUT	\.	OVEDEL OW
BLKG	BLOCKING	NOM.	NOMINAL			×	OVERFLOW
BUR	BUILT-UP ROOF	N.T.S.	NOT TO SCALE	===	PARAPET WALL		D 0 1 1 1 0 D 0 1 1 T
C.I.	CAST IRON	O.C.	ON CENTER			•	DOWNSPOUT
		O.D.	OUTSIDE DIAMETER		EXISTING RIDGE/VALLEY		
CLG.	CEILING	O.D. OF	OVERFLOW		LINE		SCUPPER OR OVERFLOW
CLKG	CAULKING	OPNG.	OPENING				SCUPPER
COL.	COLUMN				CRICKET LINE		
CONC.	CONCRETE	OPP.	OPPOSITE			F	ANTENNA
CONN.	CONNECTION	PL.	PLATE		- CONDUIT(S) PIPES		
CONSTR	CONSTRUCTION	PLYWD	PLYWOOD		00110011(0) 111 20	o_f	FLUE
CONT.	CONTINUOUS	PRCST.	PRE-CAST		ON WOOD SLEEPERS	·	
CTSK.	COUNTER SUNK	Q.T.	QUARRY TILE		ON WOOD SELLI LINS	0	PLUMBING VENT
CTR.	CENTER	RAD.	RADIUS		- EXPANSION JOINT		. 20.00.00
CTYD	COURTYARD	RD	ROOF DRAIN		- EXPANSION JUINT	Паа	ELECTRICAL PENETRATION
DBL.	DOUBLE	REF.	REFERENCE			₽.E.e	ELLO INTO AL I LIVETIMATION
DET.	DETAIL	REINF.	REINFORCED	F	FAN UNIT	0.0	GAS PENETRATION
DIA.	DIAMETER	REQ.	REQUIRED			G, G	GAS FLINE INATION
DIM.	DIMENSION	RGTR.	REGISTERED		J HATCH		DOOF MOUNTED
D.O.	DOOR OPENING	RM.	ROOM			\$	ROOF MOUNTED
DR.	DOOR	RWD.	REDWOOD	S	SKYLIGHT	4	SPEAKER/ALARM
DS.	DOWNSPOUT	R.W.L.	RAIN WATER LEADER			~.	
		S	SOUTH OR SKYLIGHT	J	J—VENT	$\exists \triangleright$	ROOF MOUNTED LIGHT
(E) OR EXIST	EXISTING	SCHED.	SCHEDULE				
	EAST	SECT.	SECTION	SM	SMOKE HATCH	A ●	ABANDONED
EA.	EACH	SHT.	SHEET				PENETRATION
E.J.	EXPANSION JOINT	SIM.	SIMILAR		ŊVENT UNIT		
EL.	ELEVATION	SM			_	⊘ HS	HOT STACK
ELEC.	ELECTRICAL		SHEET METAL		DUCT PENETRATION		
EQ.	EQUAL	SPEC.	SPECIFICATION			EL.=#	ELEVATION
EXT.	EXTERIOR	SQ.	SQUARE		GRAVITY VENT		
F	FAN	SS	STAINLESS STEEL		010700111 12101		SLOPE (DOWNWARD)
F.A.	FIRE ALARM	ST.	STEEL		SLEEPER, HEAVY AND		SEOTE (BOWNWARD)
F.D.	FLOOR DRAIN	STD.	STANDARD		FLOATING		ROOF CROSS-SECTION
FDN.	FOUNDATION	SUSP.	SUSPENDED		1 20/(11110	#	INDICATOR
FL.	FLOOR	SYM.	SYMETRICAL		ROOF DRAIN LEADER		INDICATOR
FLASH.	FLASHING	T & G	TONGUE AND GROOVE	HL		ET	DUCTWODK
FT.	FOOT OR FEET	THK.	THICK		EXIT	IDT	DUCTWORK
FTG.	FOOTING	TRP	TRIPLE				DOV
GA.	GAUGE	TYP.	TYPICAL	[AC]	HVAC UNIT	В	BOX
GALV.	GALVANIZED	U.N.O.	UNLESS NOTED OTHERWISE		DI ATEODIA		1 ADDED
GSM	GALVANIZED SHEET	V.I.F.	VERIFY IN FIELD	P	PLATFORM	Н	LADDER
OOIVI	METAL METAL	W	WEST				
GWB.	GYPSUM BOARD	 W/	WITH		GANGED PENETRATION	GREY	EXISTING COMPONENT
GWB. H.B.	HOSE BIB	W.C.	WATER CLOSET				
н.в. HGT.	HEIGHT	WD	WOOD		SECURITY CAMERA	AV	ATTIC VENT
	HEATING VENTUATION						

WITHOUT

WEIGHT

PROJECT	D-1241 ROOF REPLACEMENT LEARNING CENTER DIABLO VALLEY COLLEGE	PLEASANT HILL, CALIFORNIA	OWNER	CONTRA COSTA COMMUNITY COLLEGE DISTRICT	MARTINEZ, CALIFORNIA
	5/24/24	BIC	EY		
NO	DATE	הרככ			


NO. DATE DESCRIPTION BY PROJECT NO. 24008 CADD FILE DESIGNED BY DRAWN BY CHECKED BY 2 APR 2024 DRAWING SCALE SHEET TITLE TITLE SHEET,


DATE

GENERAL NOTES, ABBREVIATIONS AND LEGEND DRAWING NO.

A1.0

OF

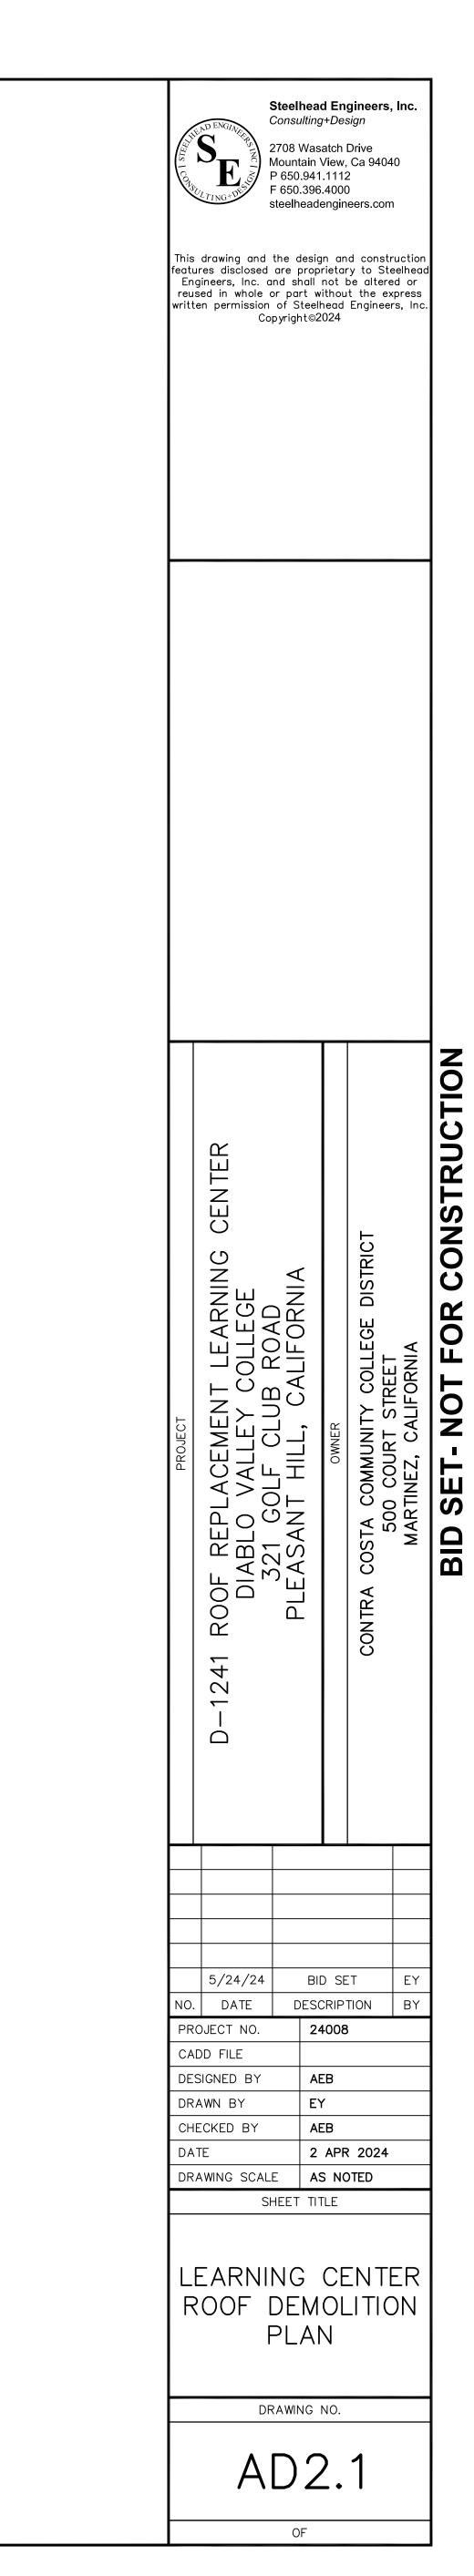

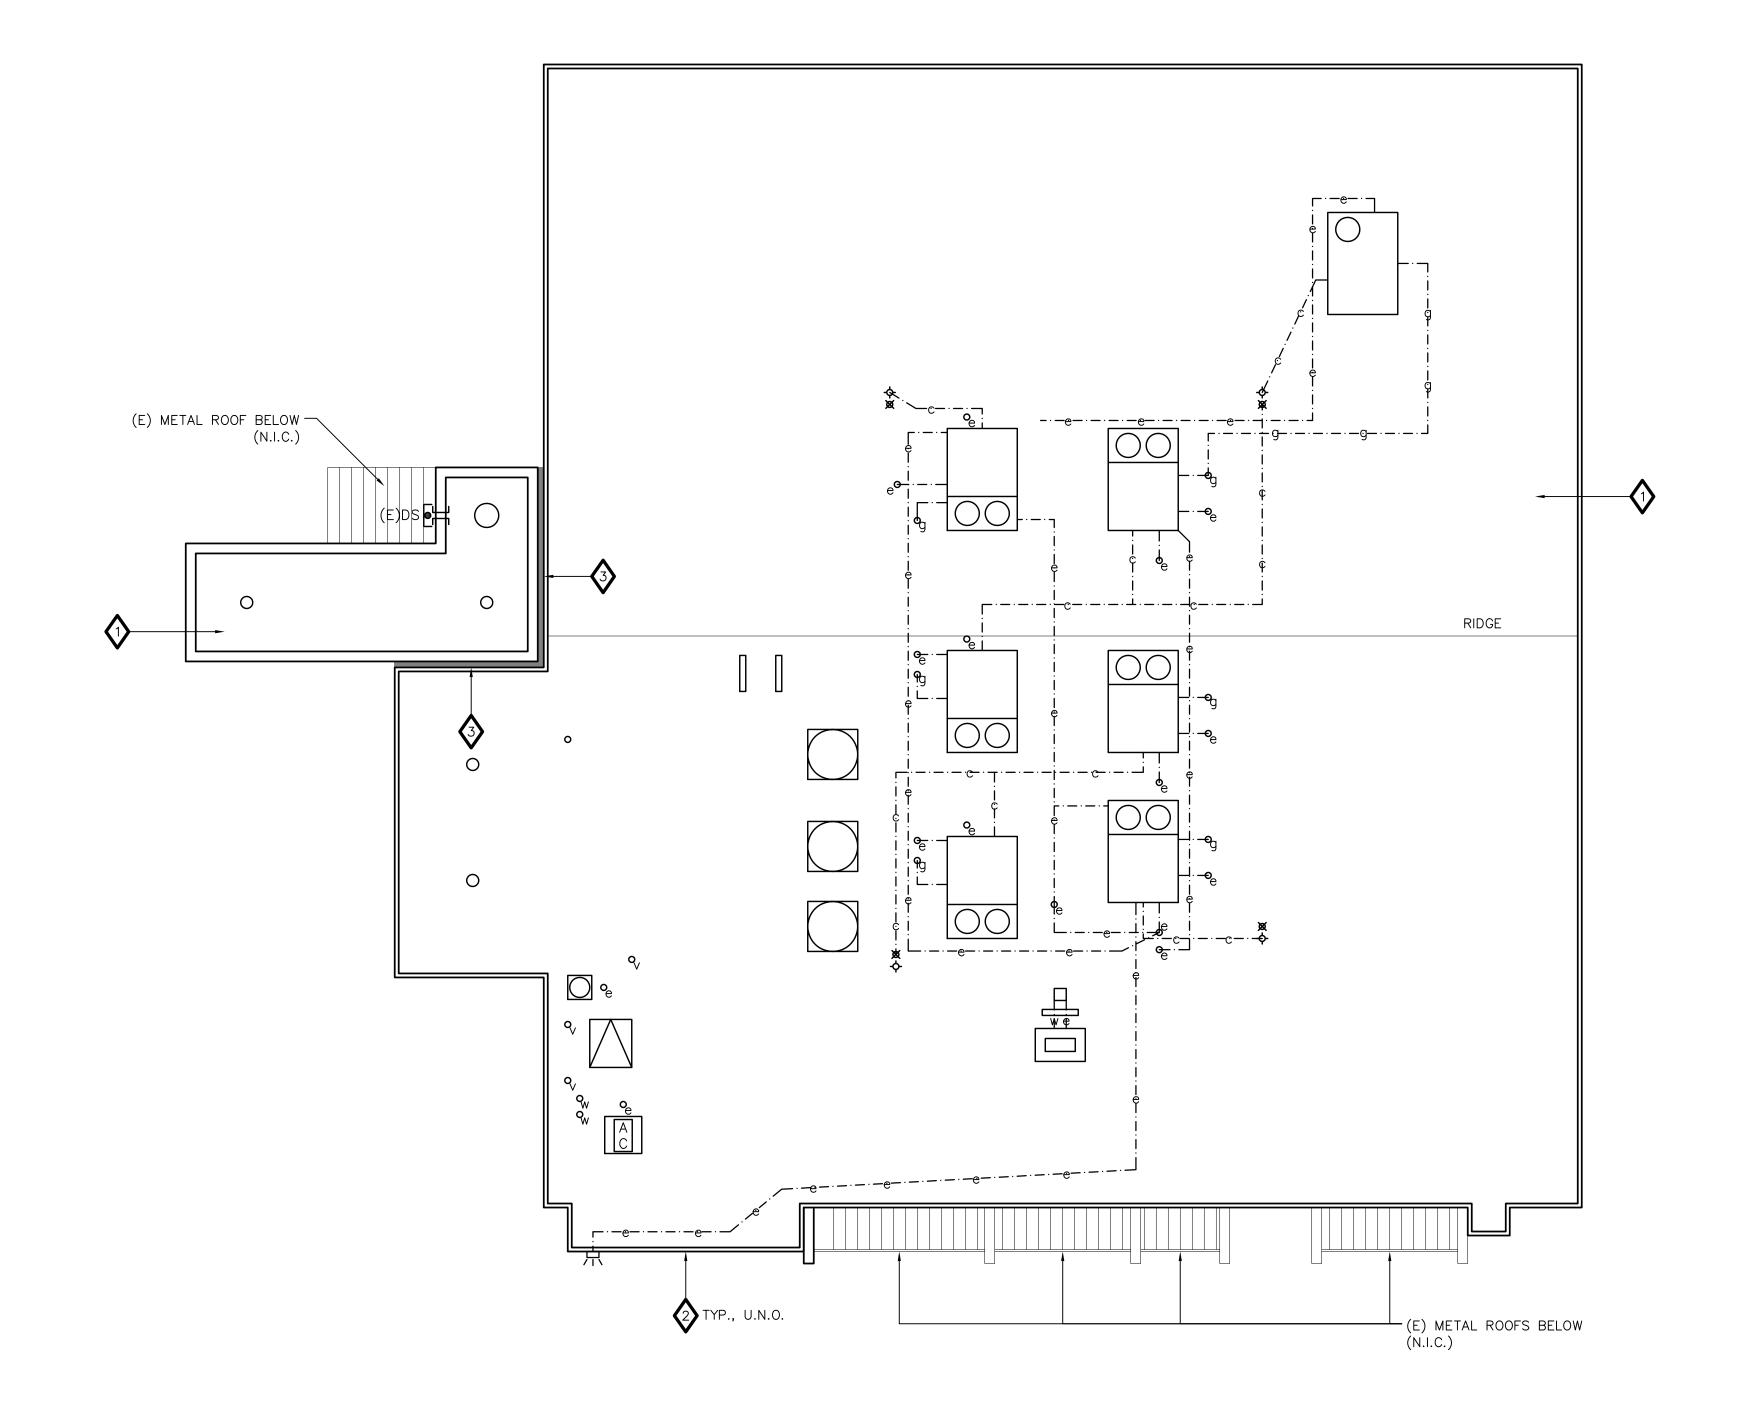

ROOF DEMOLITION KEY NOTES:

REMOVE (E) BUILT-UP ROOF SYSTEM

2 REMOVE (E) EDGE METAL

REMOVE (E) SEISMIC JOINT COVER

4 REMOVE (E) CONDUIT AND REMOVE (E) WOOD SLEEPERS


(1) THE (E) HATCH, VENTS, CONDUITS, PIPES, MECHANICAL UNITS WITH SHEET METAL FLASHINGS, COLLECTOR HEAD AND DOWNSPOUT, AND FLUES SHALL REMAIN.

1 LEARNING CENTER ROOF DEMOLITION PLAN

SCALE: 1/8"=1'-0"





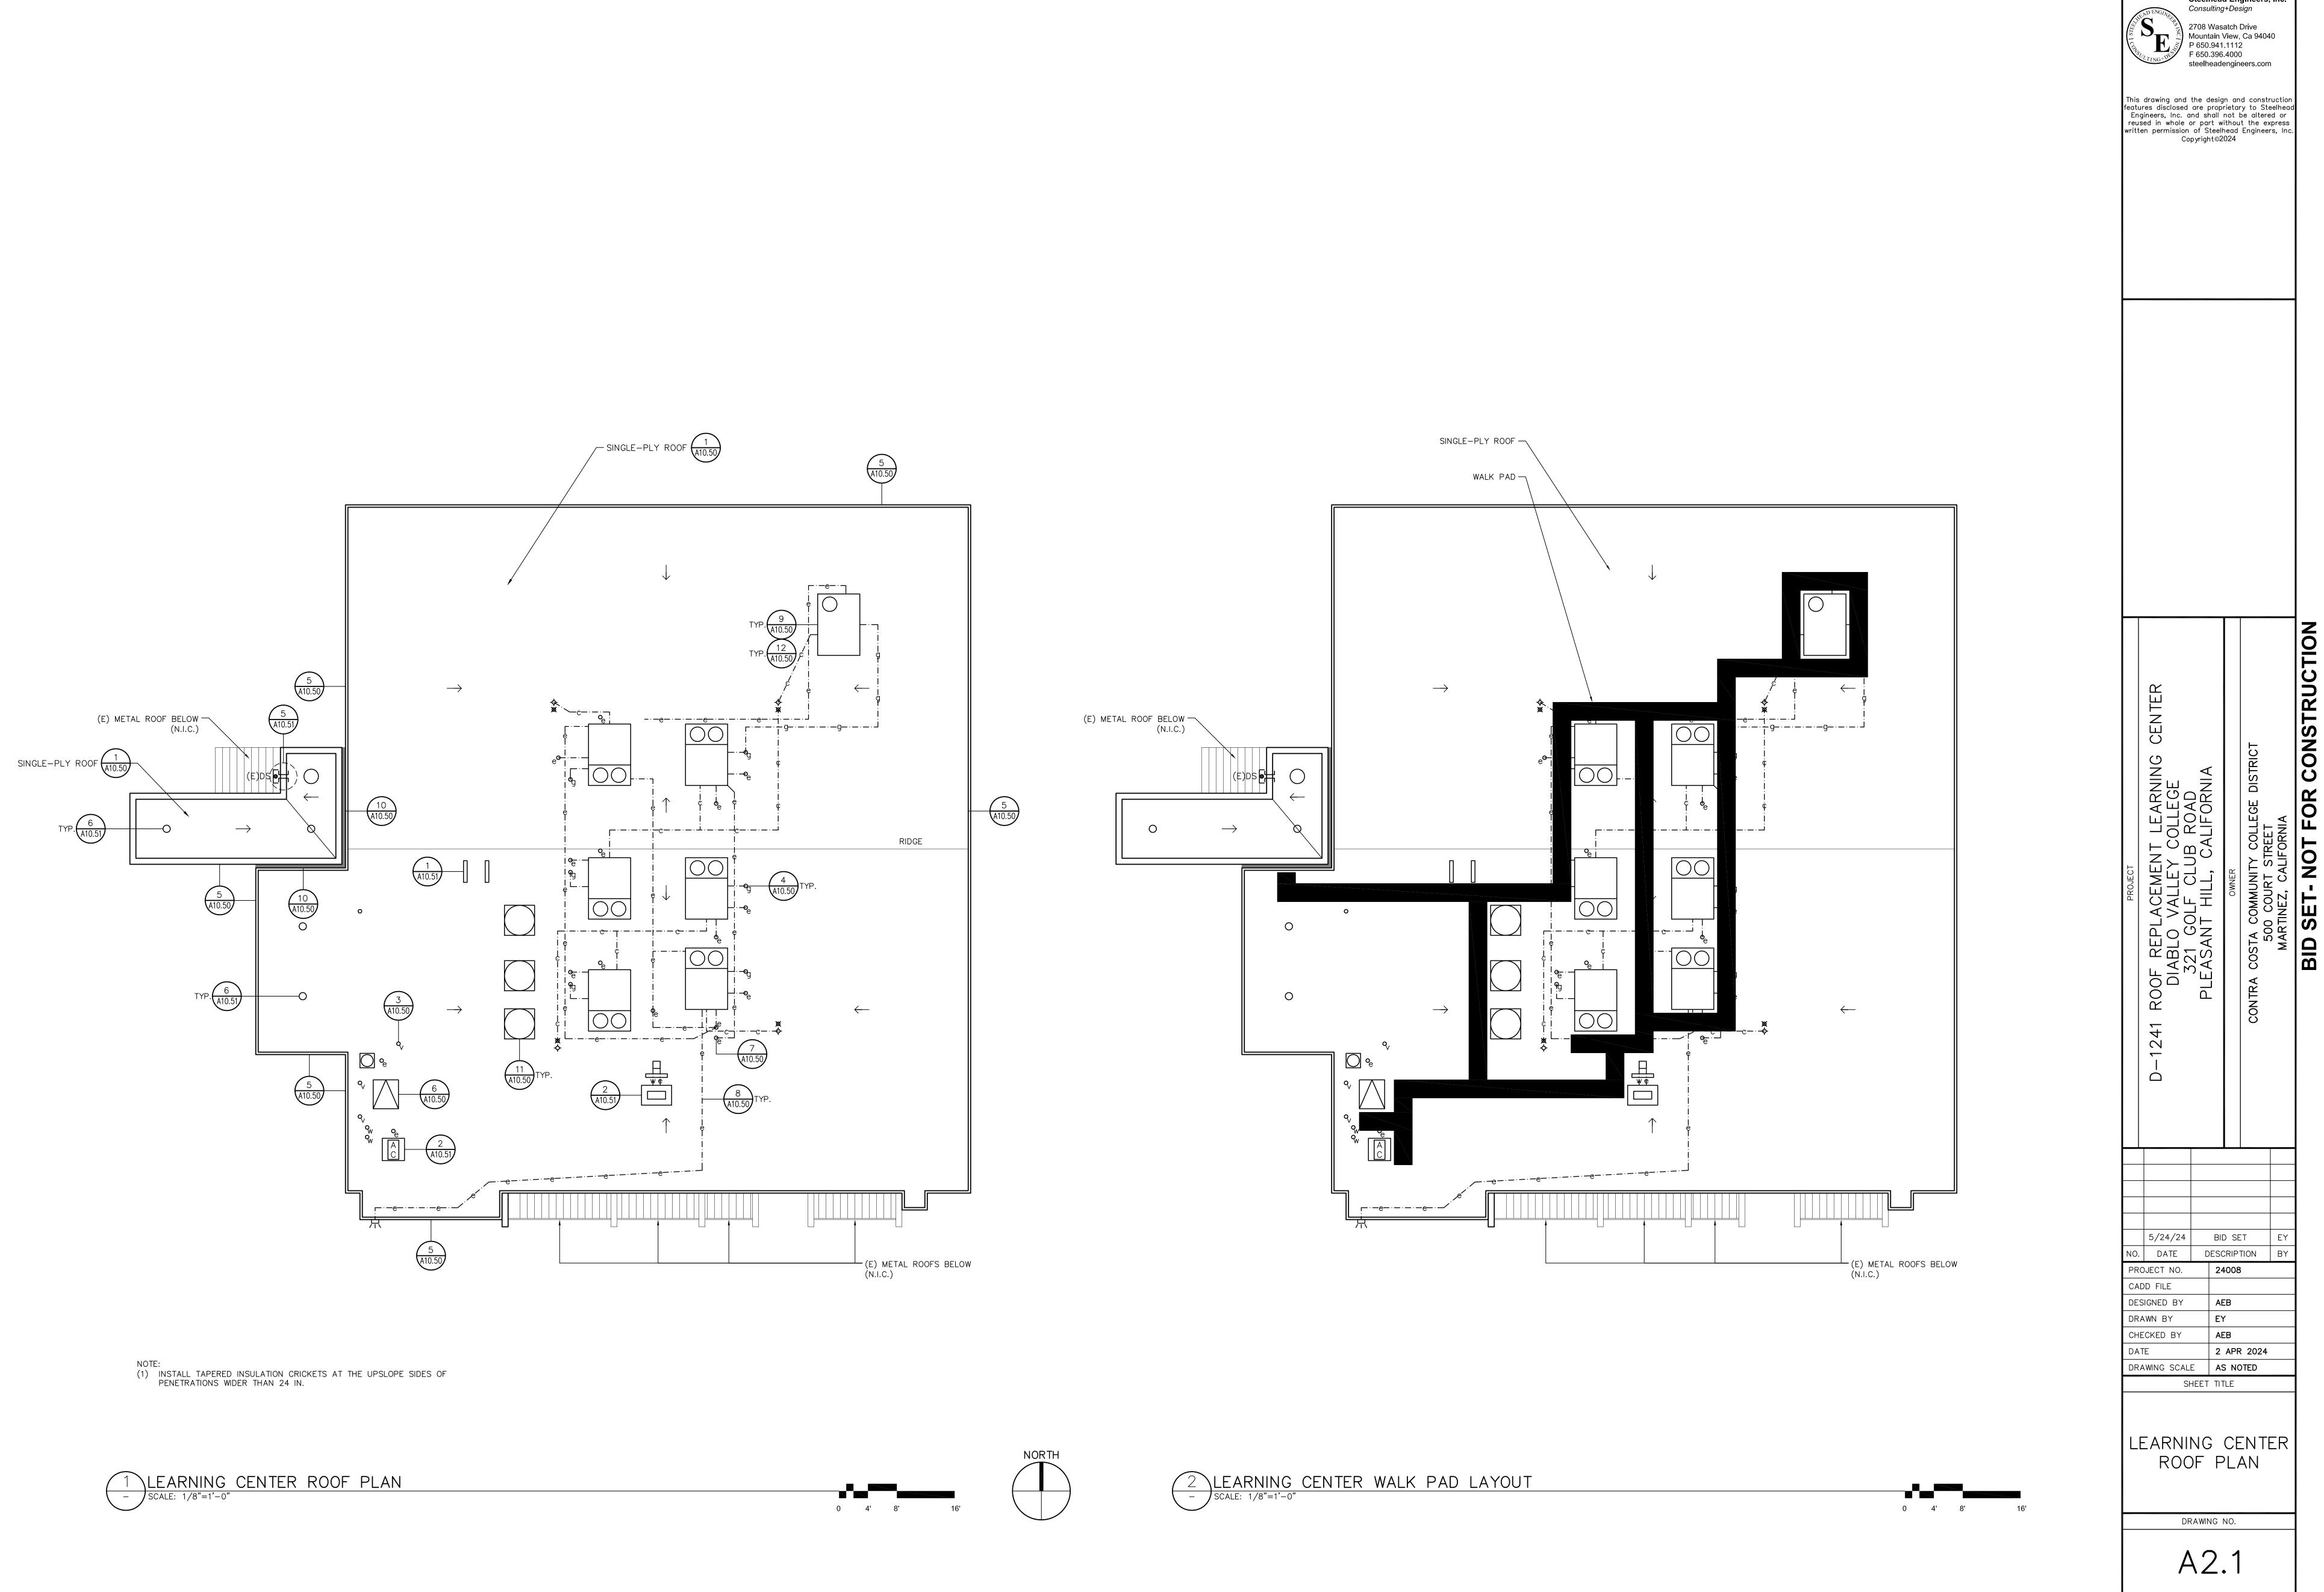

Steelhead Engineers, Inc.

OF

