

### **BID DOCUMENTS COVER SHEET**

**CONTRACT DOCUMENTS** 

**FOR** 

# L-1161 CONFERENCE ROOM & COMMUNITY ROOM AUDIO-VISUAL UPGRADES

AT

Los Medanos College 2700 East Leland Road, Pittsburg, CA 94565

CONTRA COSTA COMMUNITY COLLEGE DISTRICT

Consists of the following:

# VOLUME 2 DRAWINGS

DSA Appl. #01-119293


Architect:


### SMITH, FAUSE & McDONALD, INC.


San Francisco, CA 94103 Tel (415) 255-9140


February 19, 2021


# COMMUNITY AND CONFERENCE ROOMS AV UPGRADES LOS MEDANOS COLLEGE 2700 E. LELAND ROAD, PITTSBURG, CALIFORNIA

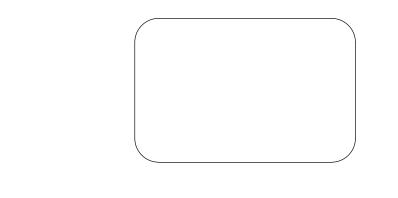

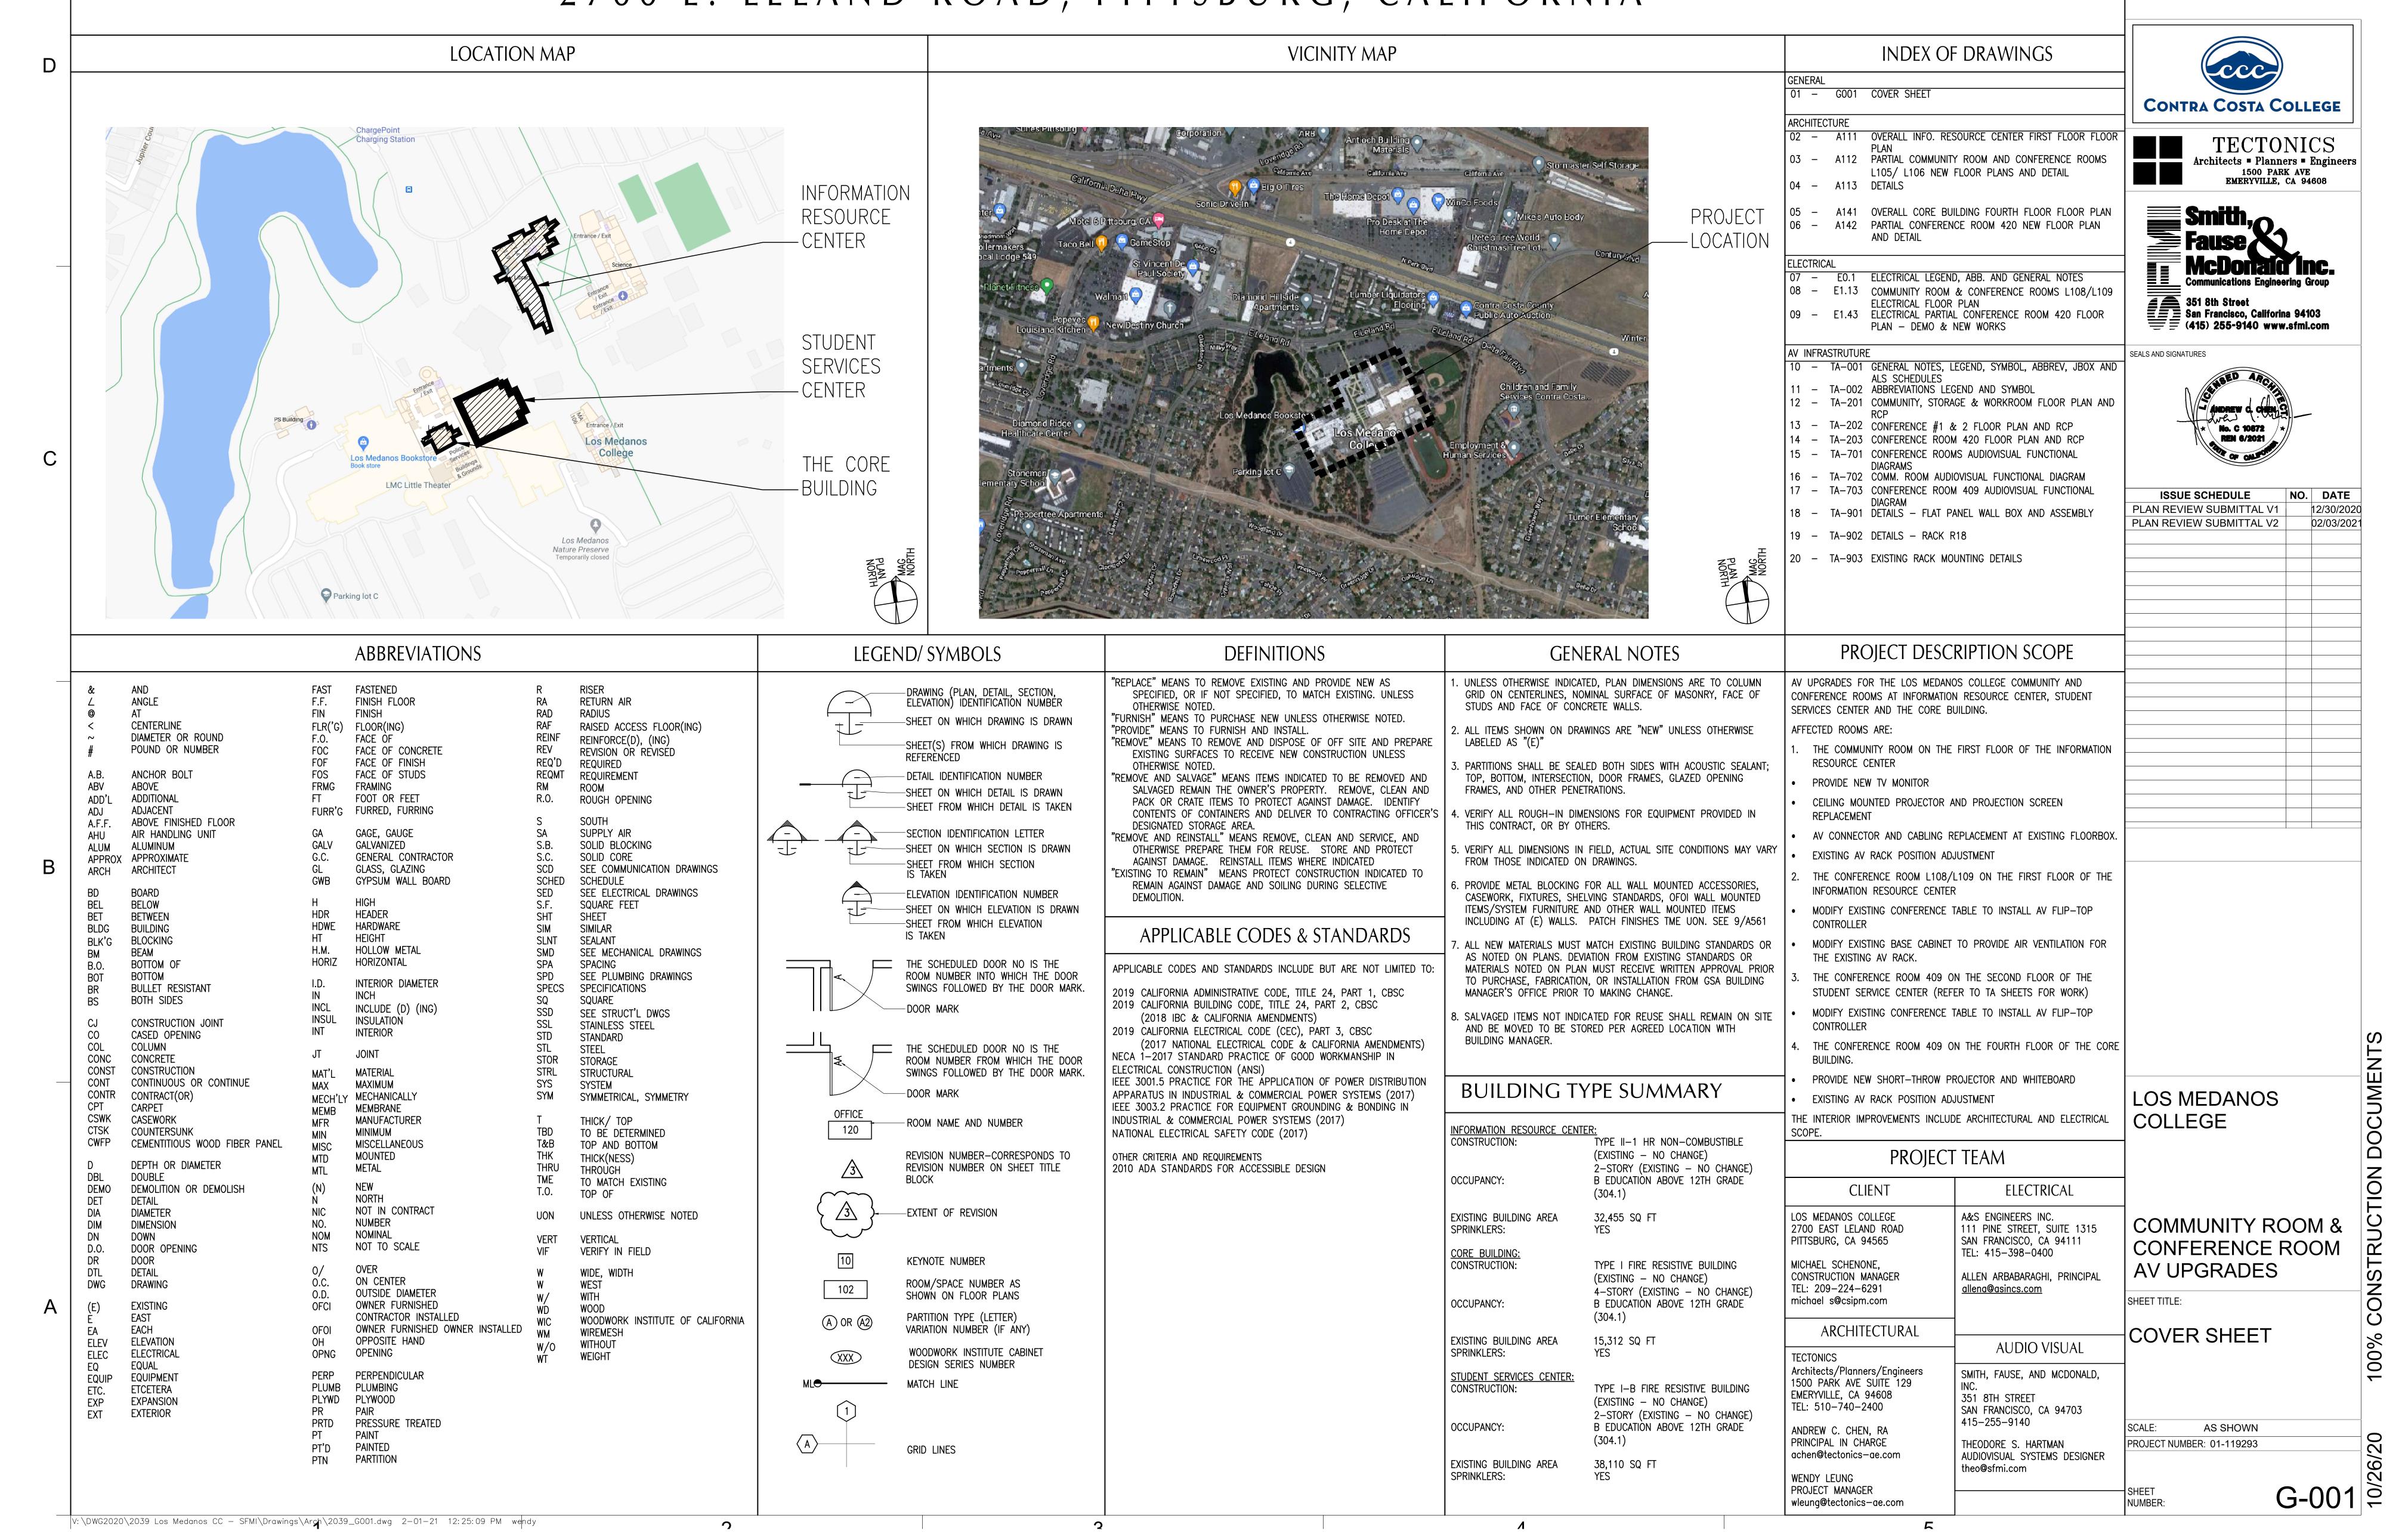

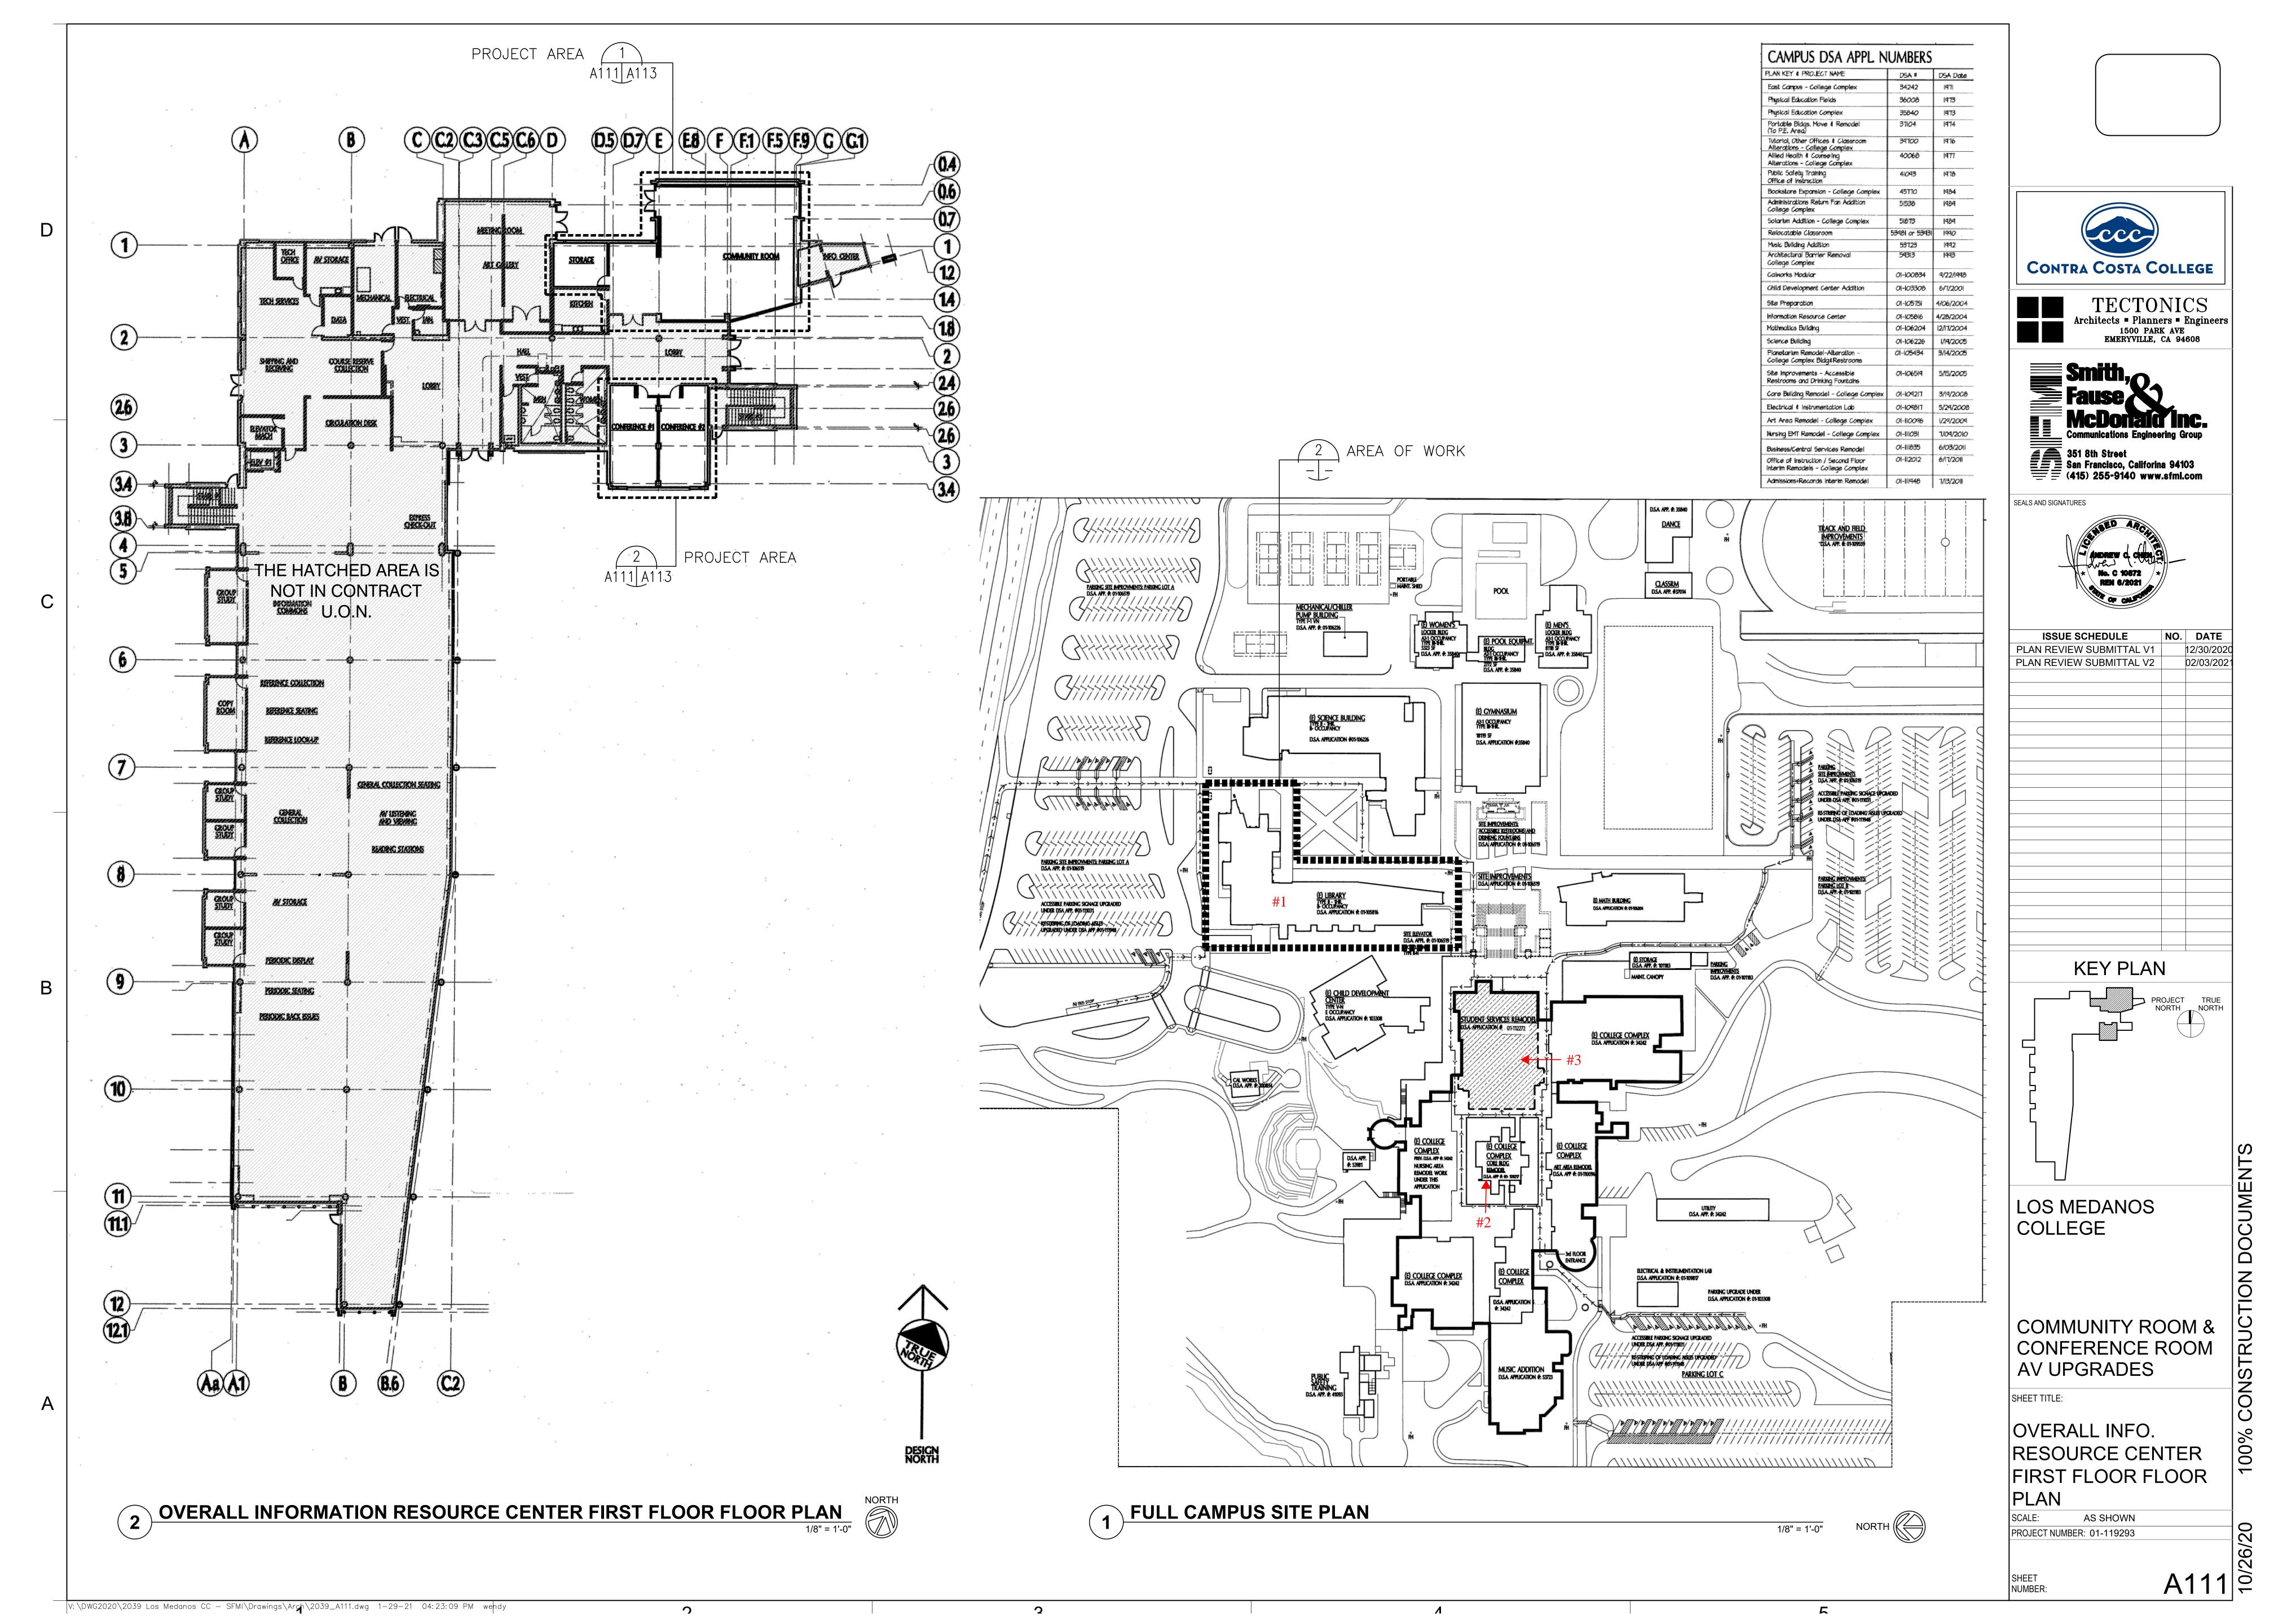

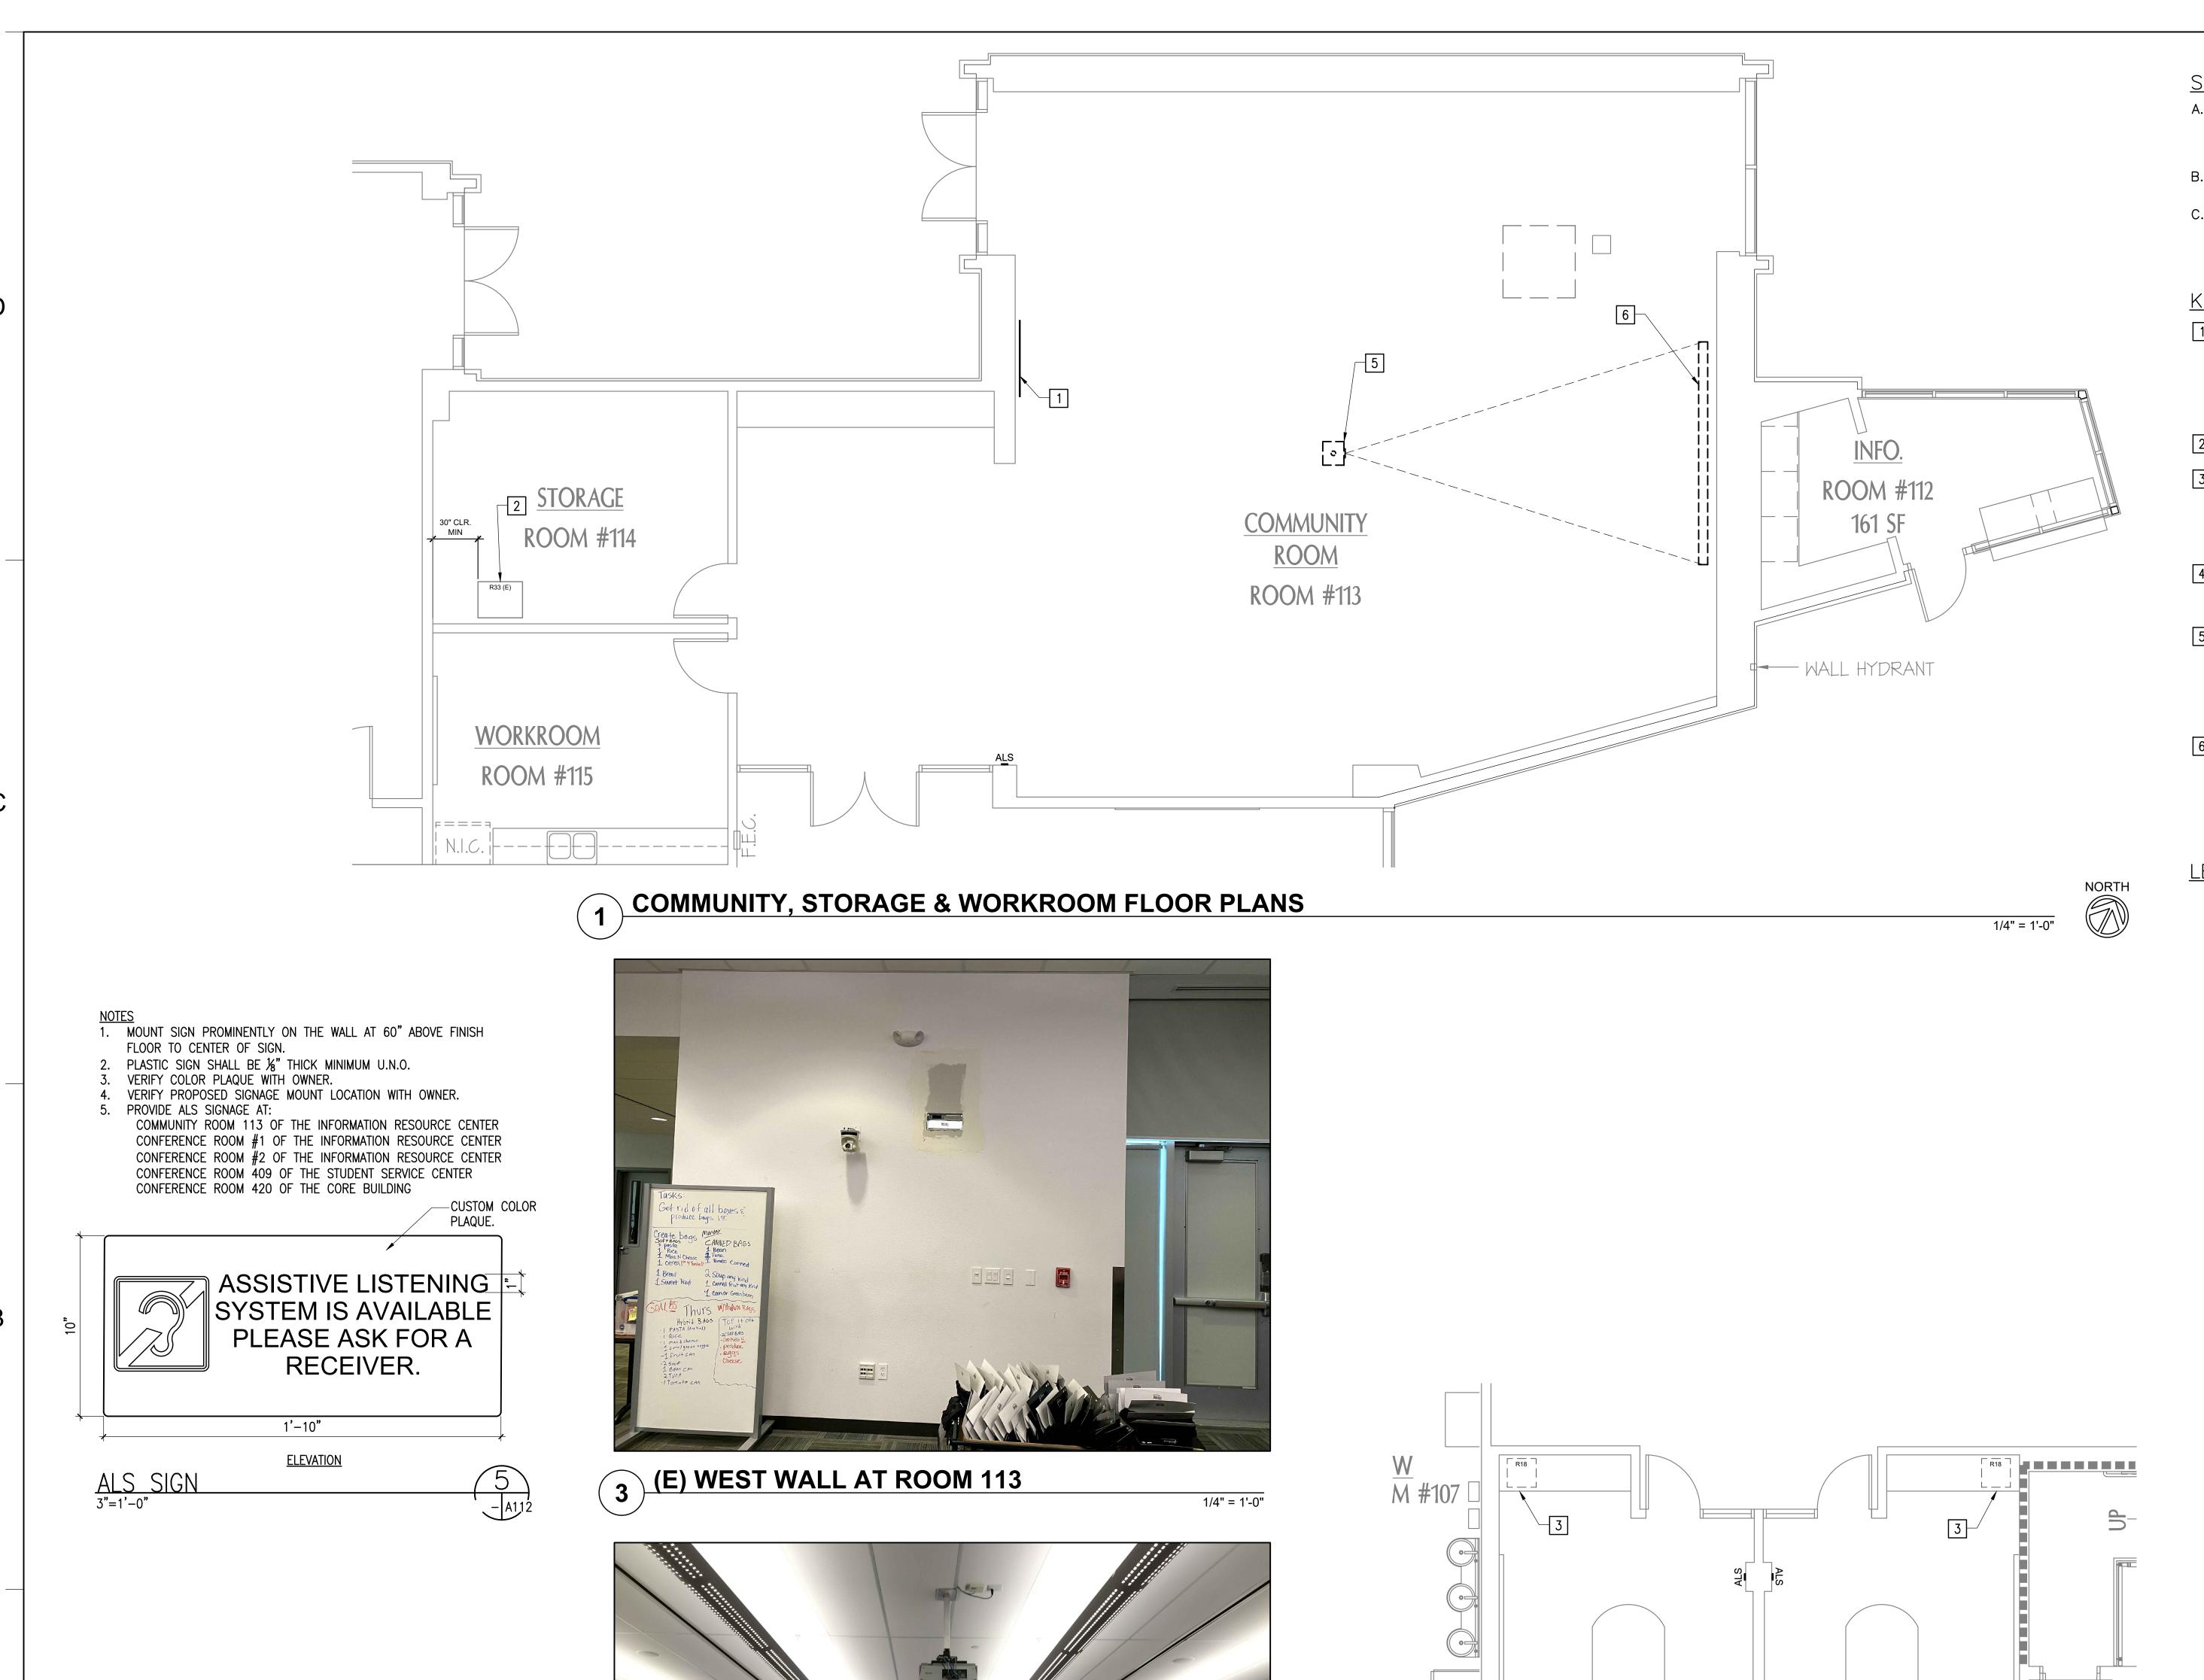

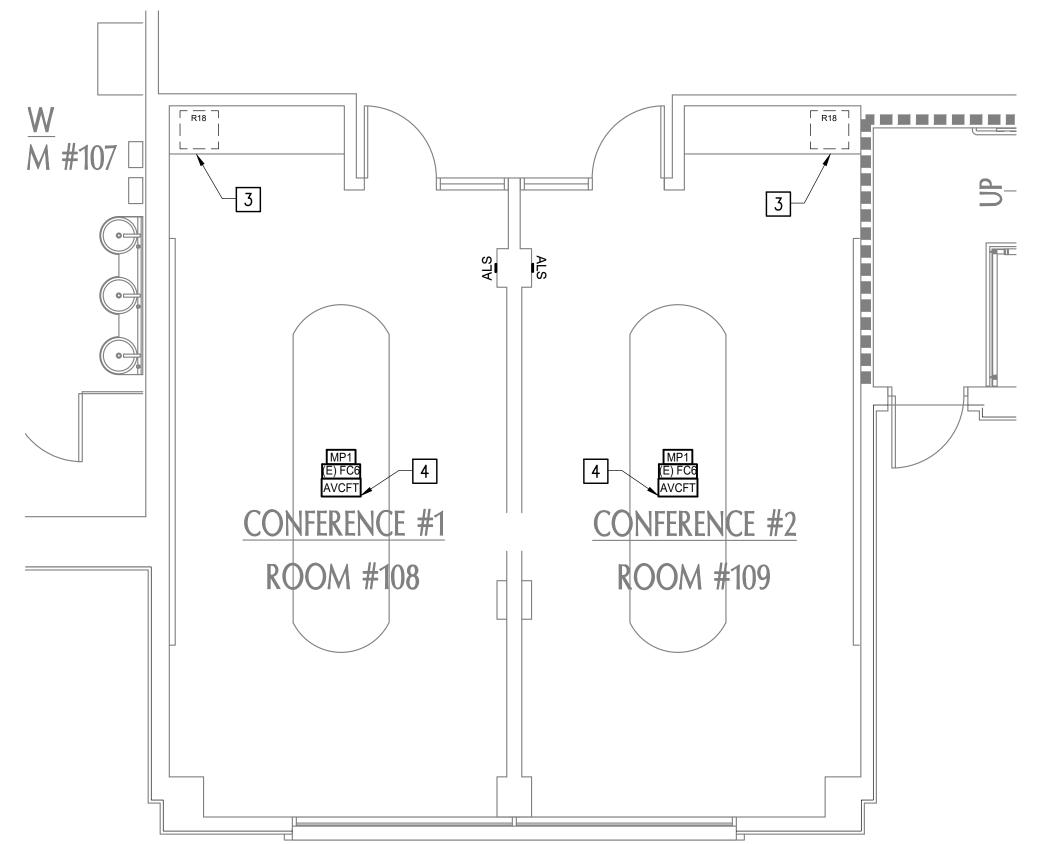

CONFERENCE ROOMS L108/ L109 FLOOR PLANS

### SHEET NOTES

- A. REFER TO TA SHEETS FOR AUDIO VISUAL DESIGN REQUIREMENTS AND ADDITIONAL NEW WORK TO BE PERFORMED.
  - B. REMOVE (E) WALL FINISHES TO INSTALL BACKING PLATES. PATCH TME.
- C. PROVIDE METAL BACKING PLATES BETWEEN STUDS AT ALL LOCATIONS REQUIRED FOR ATTACHMENT OF WALL-MOUNTED ITEMS, SEE DETAIL 1/A113.

### **KEYNOTES**

1 PROVIDE 70" WALL MOUNTED TELEVISION AND H CHIEF LTM SERIES OR EQUAL MOUNTING RACK. THE 70" TELEVISION TO BE MOUNTED AT 80" AFF TO THE UNDERSIDE OF SCREEN. REFER TO TA SHEETS FOR MOUNTING BRACKET INFORMATION. PROVIDE POWER AND DATA CONNECTIVITY AS REQUIRED.

### 2 EXISTING SERVER RACKS.

- MODIFY THE EXISTING BASE CABINET TO PROVIDE AIR VENTILATION FOR THE EXISTING AV RACK. GC TO CUT OUT A 1/4" SLOT AT THE UNDERSIDE OF THE TOE KICK AND TO ADD LOUVERS AT THE CABINET DOORS. REFER TO TA SHEETS FOR ADDITIONAL INFORMATION.
- MODIFY EXISTING CONFERENCE TABLE TO INSTALL THE NEW FLIP—TOP CONTROLLER AND CABLE CUBBY. REFER TO TA SHEETS FOR ADDITIONAL INFORMATION.
- 5 PROVIDE CEILING MOUNTED PROJECTOR. GC TO INSTALL THE NEW PROJECTOR PER DETAIL 2,3/A113 AND ADJUST THE EXTENSION POLE ACCORDINGLY FOR PROPER ALIGNMENT WITH THE SCREEN. REFER TO TA SHEETS FOR ADDITIONAL INFORMATION.
- PROVIDE CEILING MOUNTED PROJECTION SCREEN. GC TO INSTALL THE NEW PROJECTION SCREEN PER DETAIL 4/A113. REFER TO TA SHEETS FOR ADDITIONAL INFORMATION.

### <u>LEGEND</u>


ASSISTIVE LISTENING SYSTEMS SIGN. SEE DETAIL 5/A112.

CONTRA COSTA COLLEGE TECTONICS




351 8th Street
San Francisco, Califorina 94103
(415) 255-9140 www.sfmi.com

Architects - Planners - Engineers

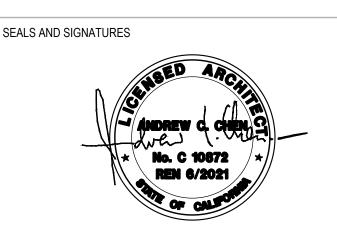

NO. DATE ISSUE SCHEDULE PLAN REVIEW SUBMITTAL V1 12/30/2020 PLAN REVIEW SUBMITTAL V2

**KEY PLAN** 

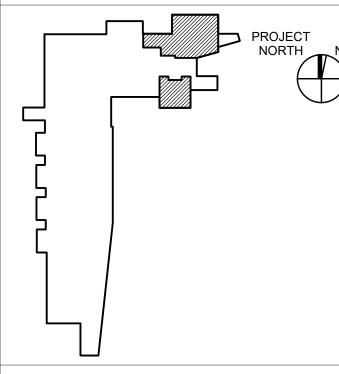

LOS MEDANOS COLLEGE

COMMUNITY ROOM & CONFERENCE ROOM **AV UPGRADES** 

SHEET TITLE:

COMMUNITY AND CONFERENCE ROOMS L108/ L109 NEW FLOOR PLANS


AS SHOWN PROJECT NUMBER: 01-119293

1/4" = 1'-0"

(E) EAST WALL AT ROOM 113

**7** 


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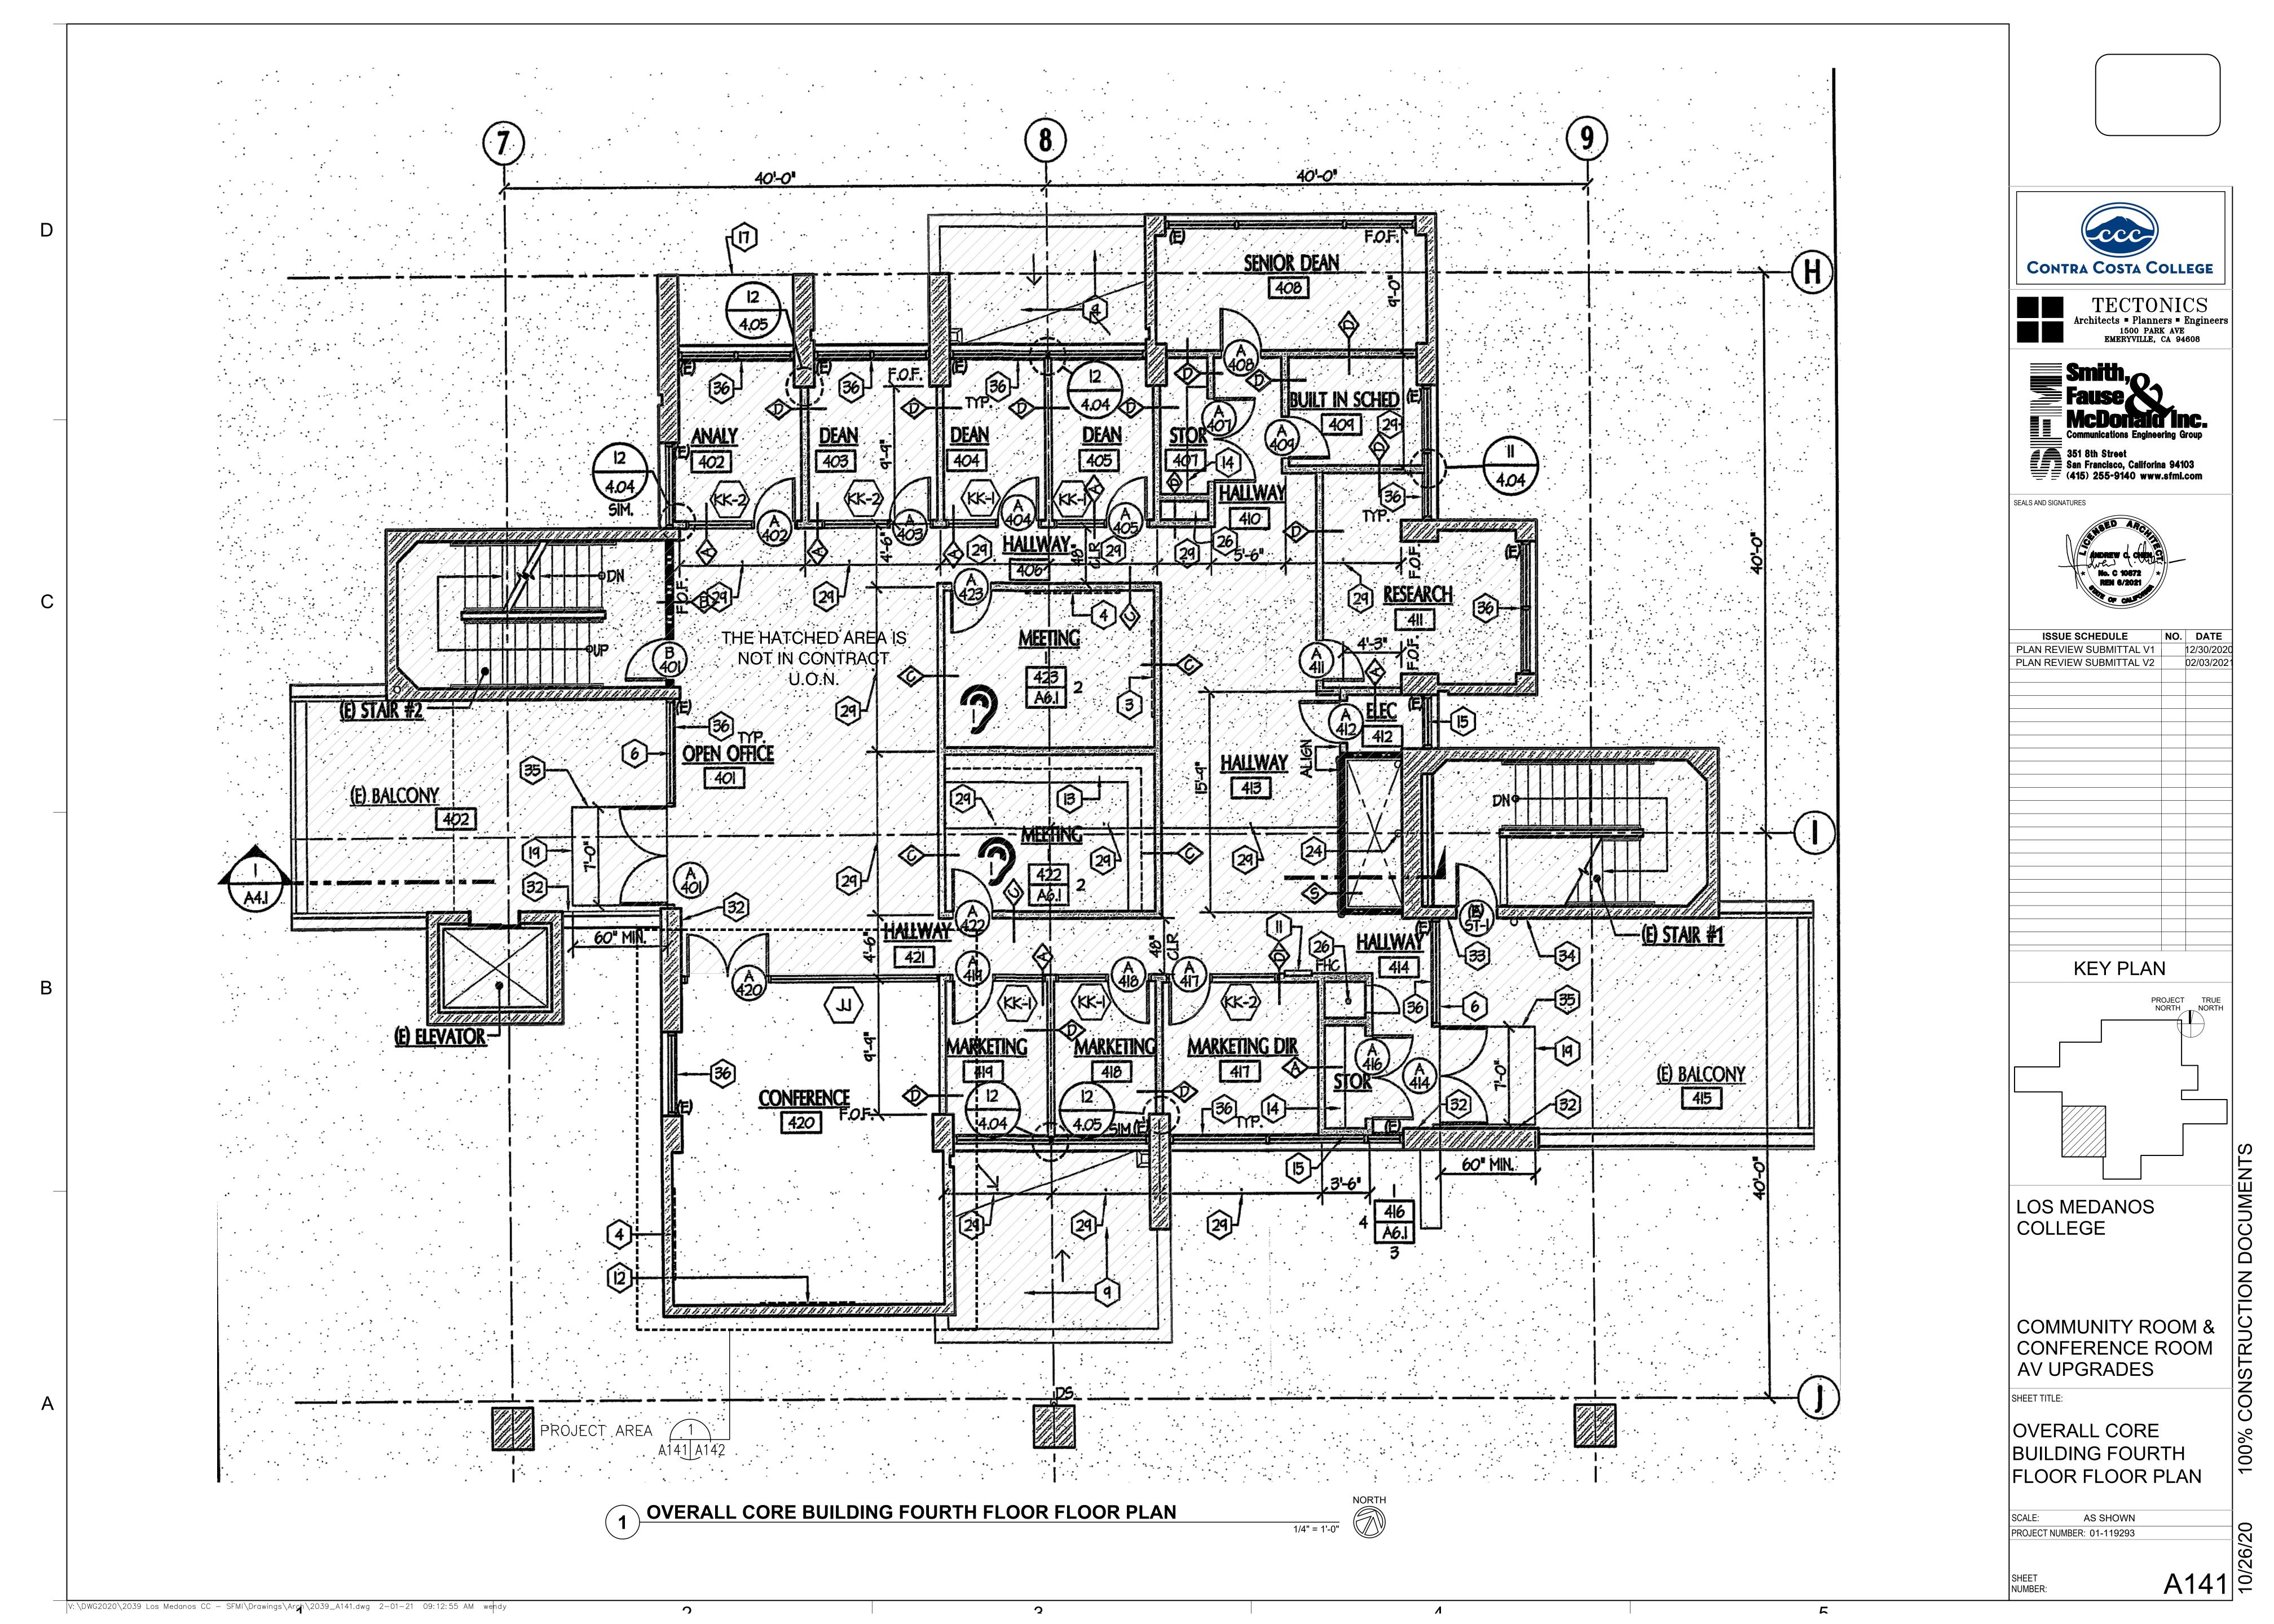


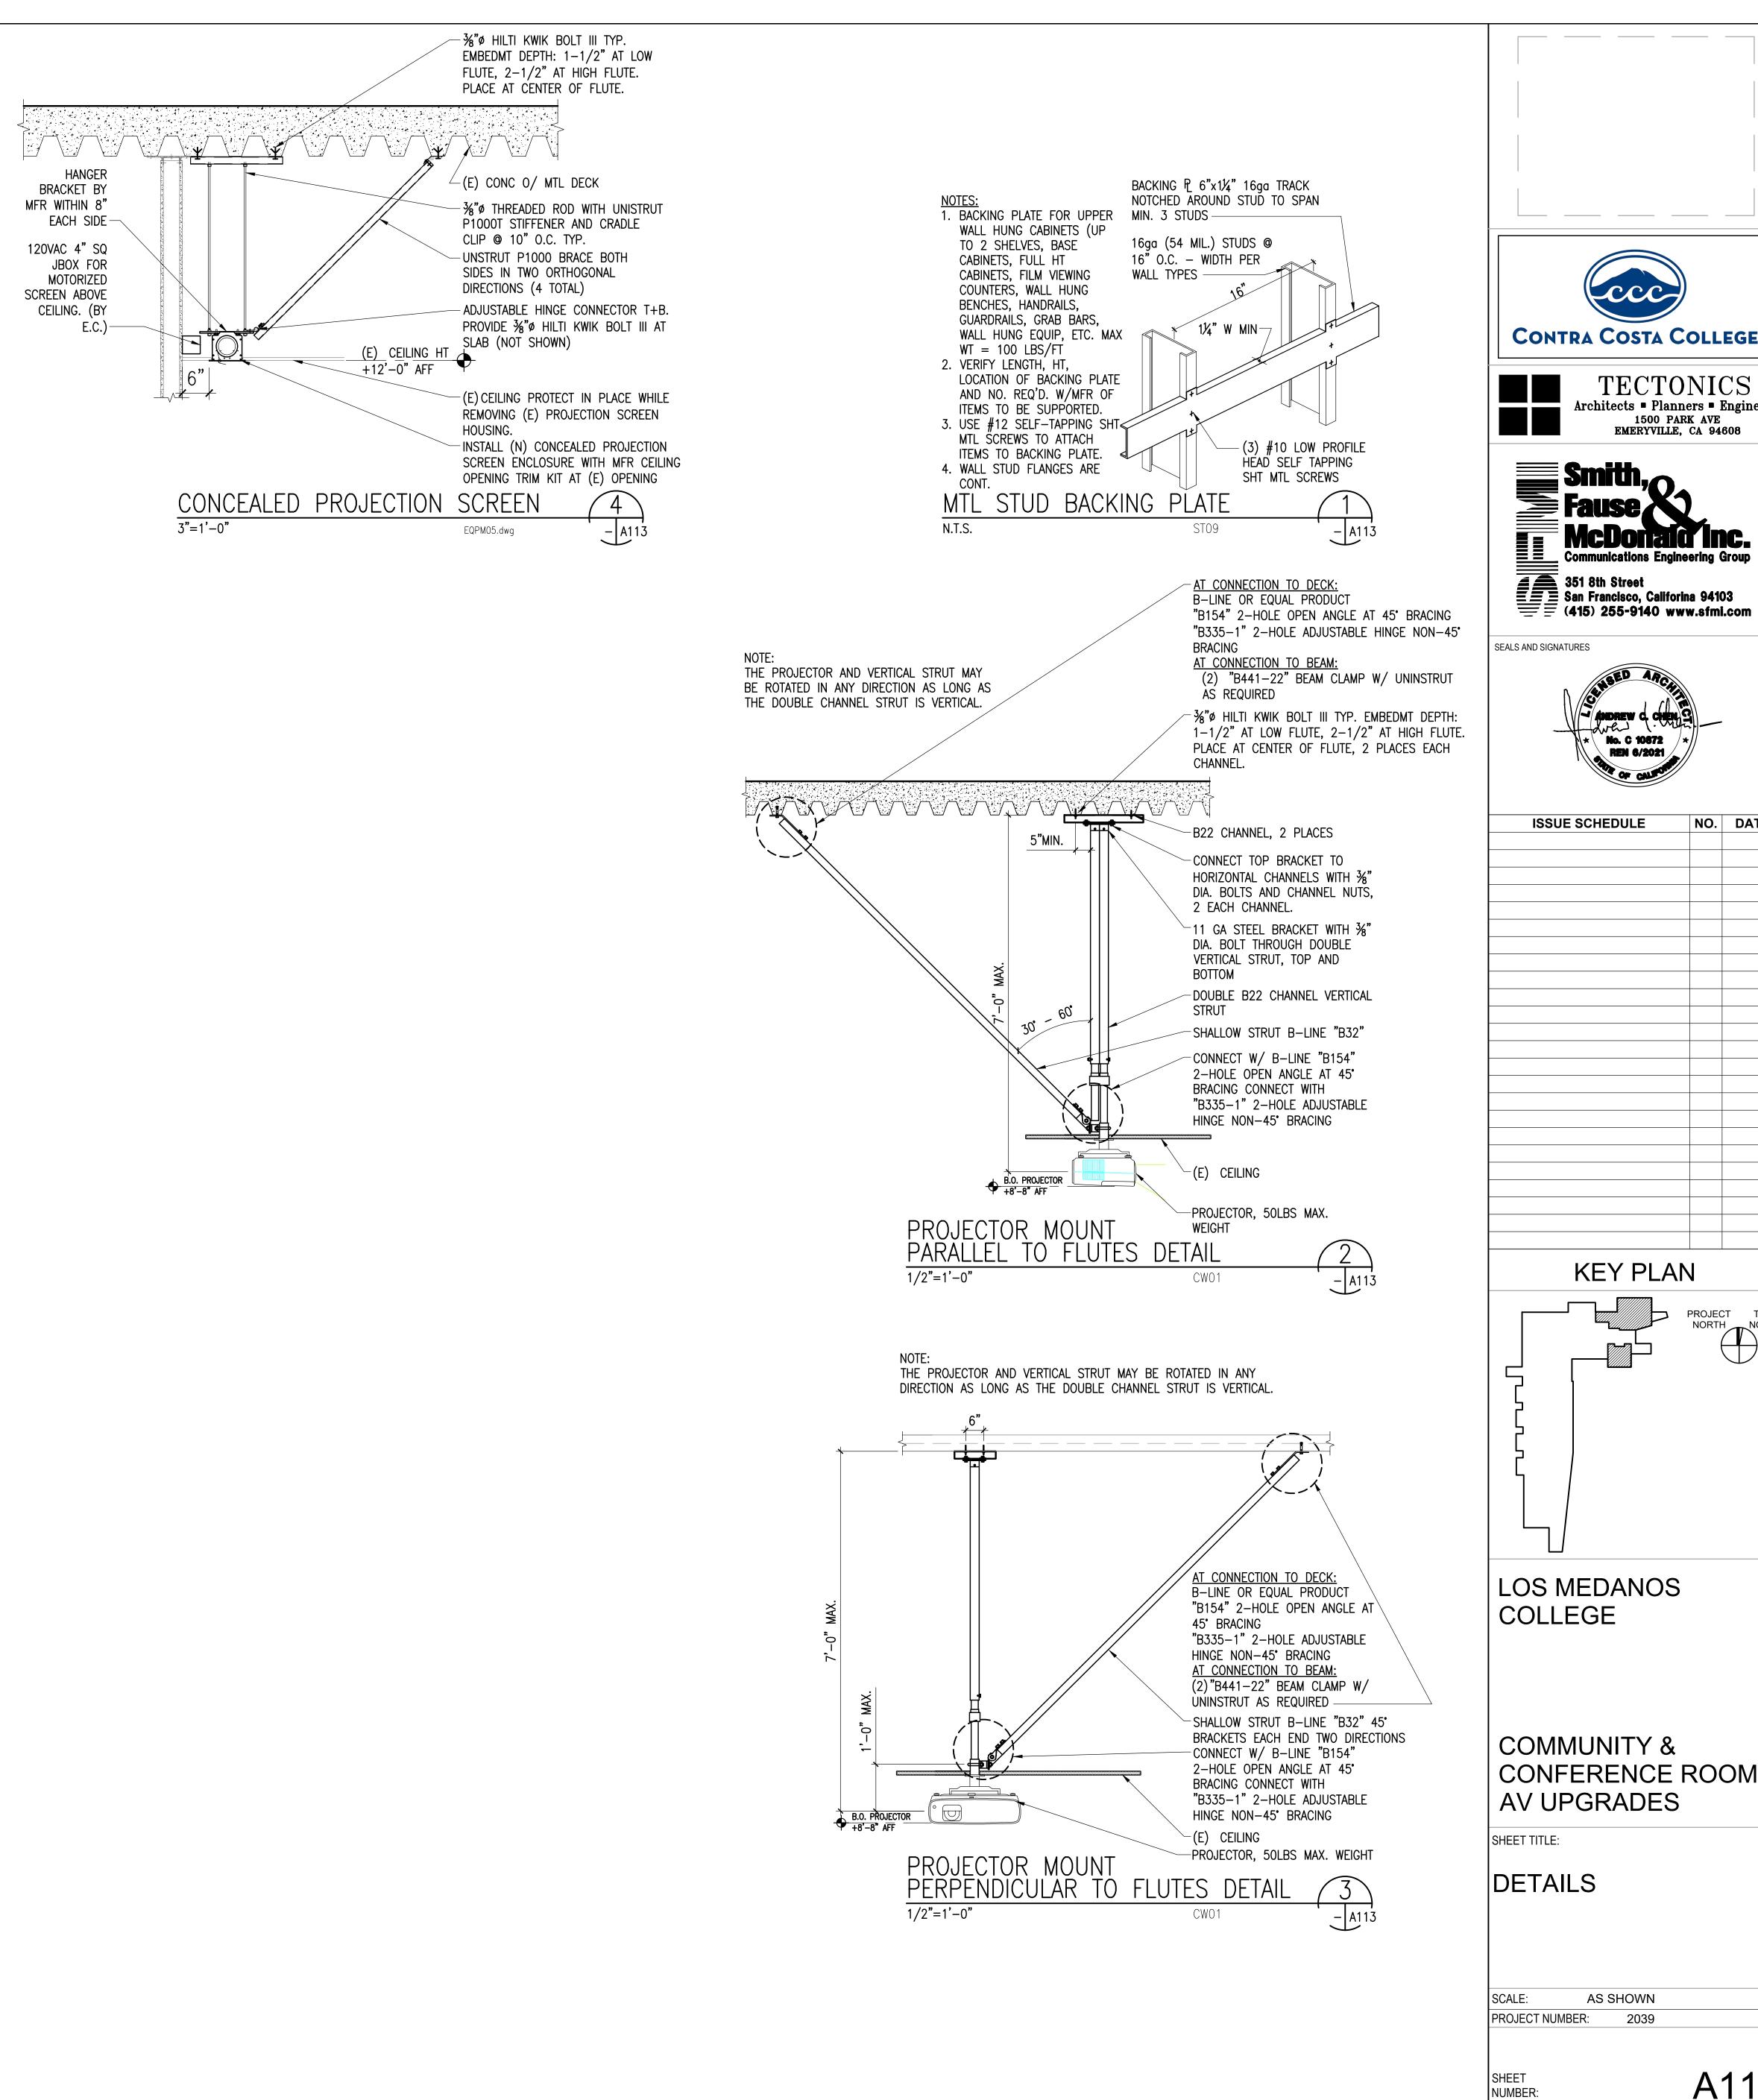

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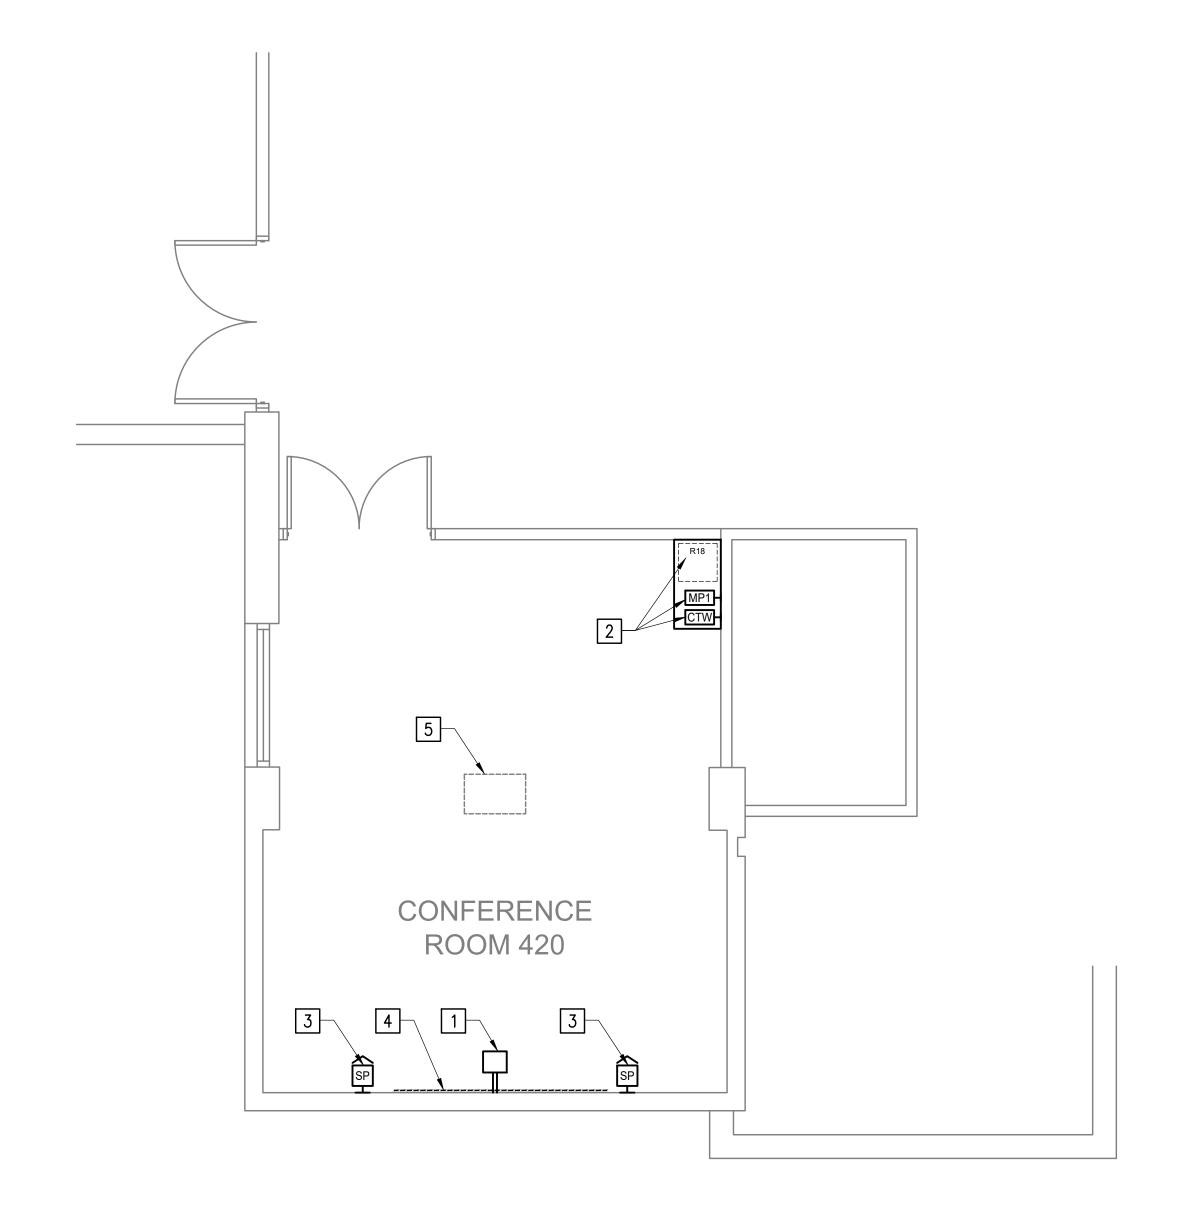
COMMUNITY & CONFERENCE ROOMS

A113

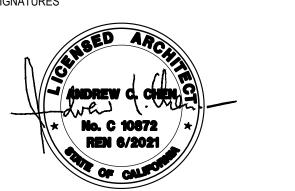

# EPSON PROPERTY OF THE PROPERTY





1 CONFERENCE ROOM 420 FLOOR PLAN
CORE BUILDING
1/4" = 1'-0"



### SHEET NOTES

A. REFER TO TA SHEETS FOR AUDIO VISUAL DESIGN REQUIREMENTS AND ADDITIONAL NEW WORK TO BE PERFORMED.

### FLOOR PLAN KEYNOTES


- PROVIDE EPSON BRIGHTLINK PRO 1430WI SHORT—THROW WALL MOUNTED PROJECTOR. PROVIDE SURFACE MOUNTED POWER AND DATA CONNECTIVITY AS REQUIRED. SEE DETAIL 4/A142 FOR MOUNTING DETAIL. REFER TO TA SHEETS FOR PRODUCT AND MOUNTING POSITION INFORMATION.
- 2 SERVER RACK AND AV EQUIPMENT. REFER TO TA SHEETS FOR ADDITIONAL INFORMATION.
- 3 PROTECT IN-PLACE EXISTING WALL MOUNTED SPEAKERS.
- REMOVE (E) WHITE BOARD AND HARDWARE, PATCH WALL TO MATCH EXISTING AS REQUIRED. PROVIDE LEGRAND DA-LITE IDEA PANORAMIC SCREEN, SEE INTERIOR ELEVATION FOR ADDITIONAL INFORMATION.
- REMOVE (E) CEILING MOUNTED PROJECTOR AND HARDWARE, PATCH SURFACES TO MATCH EXISTING AS REQUIRED. REFER TO TA SHEETS FOR ADDITIONAL INFORMATION.








SEALS AND SIGNATURES

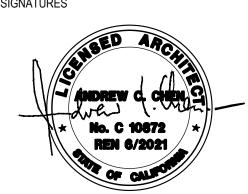

ISSUE SOUEDIN =	NO	D 4 T =
ISSUE SCHEDULE	NO.	DATE

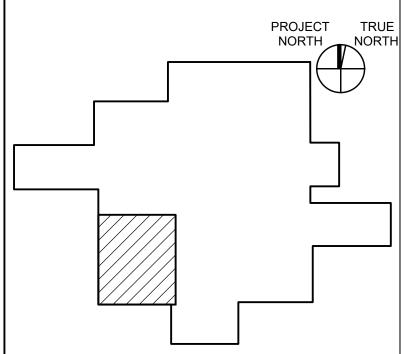

**KEY PLAN** 

- LOS MEDANOS COLLEGE
- COMMUNITY &
  CONFERENCE ROOMS
  AV UPGRADES


SHEET TITLE:

SHEET NUMBER:

PARTIAL
CONFERENCE ROOM
420 NEW FLOOR PLAN

SCALE: AS SHOWN PROJECT NUMBER: 2039

A142

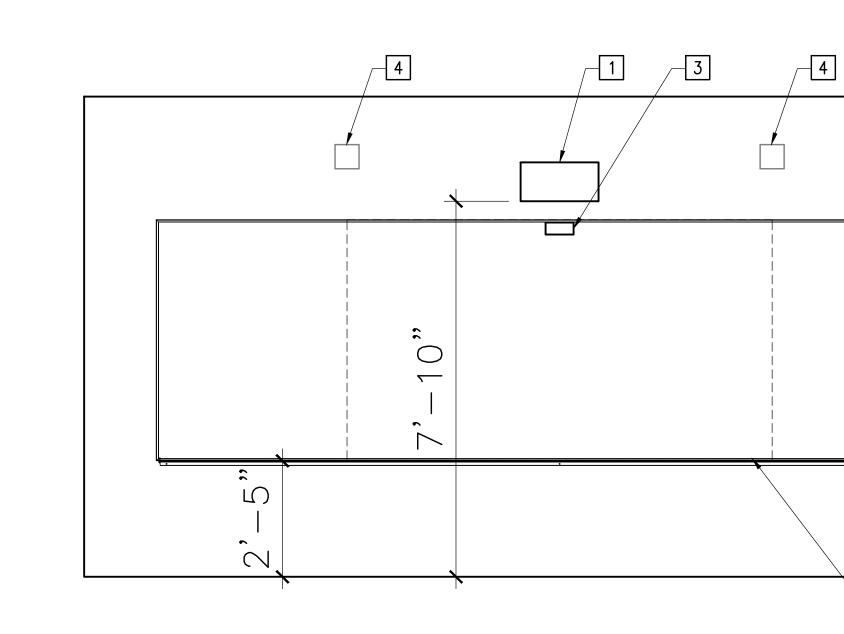

CONFERENCE ROOM 420 SOUTH INTERIOR ELEVATION
CORE BUILDING

1/2" = 1'-0"

NOTES:

1. REFER TO THE SHORT THROW PROJECTOR MANUFACTURER FOR WALL PLATE TEMPLATE TO DETERMINE THE POSITION OF THE WALL PLATE'S MOUNTING HOLES.

Steps 4 to 8 below provide instructions for attaching the wall plate to a concrete wall.

Drill holes of the following diameters and depths.

Drill diameter 0.41 in. (10.5 mm)


Pilot hole depth 1.8 in. (45 mm)

Anchor hole depth 1.6 in. (40 mm)

HILTI KWIK BOLT III (1/4" x 1.5") TYP. EMBEDMT DEPTH: 1-1/2" AT LOW FLUTE.

6. Use a device such as a dust pump to clean out concrete dust from the hole.

7. Position the wall plate on the wall and insert M10 × 60 mm expansion anchors into the holes. Attach the nut and tap it with a hammer until the core touches the top of the anchor.

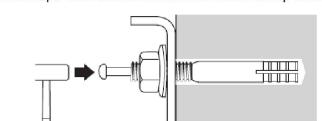

SURFACE MOUNTED PROJECTOR/PROJECTION WHITE BOARD DETAIL

N.T.S.


WMPD

-

### INTERIOR ELEVATION KEYNOTES

- PROVIDE EPSON BRIGHTLINK PRO 1430WI SHORT-THROW WALL MOUNTED PROJECTOR. PROVIDE SURFACE MOUNTED POWER AND DATA CONNECTIVITY AS REQUIRED. SEE DETAIL 4/A142 FOR MOUNTING DETAIL. REFER TO TA SHEETS FOR PRODUCT AND MOUNTING POSITION INFORMATION.
- LEGRAND DA-LITE IDEA PANORAMIC SCREEN
  27952T (CFCI), (HDTV 16:9, OVERALL SCREEN
  DIMENSION 60.25" H X 192" W AND VIEWING
  AREA OF THE SCREEN TO BE 59.5" H X 106"
  W,121" DIAGONAL WITH NO SEAMS ON THE
  SURFACE), SURFACE MOUNTED WITH FULL LENGTH
  MARKER TRAY. SEE DETAIL 4/A142
- TOUCH UNIT FOR MAGNETIC SCREEN. REFER TO MANUFACTURER INSTALLATION GUIDELINE AND POSITION.
- PROTECT IN-PLACE EXISTING WALL MOUNTED SPEAKERS.
- 5 EXISTING CONCRETE WALL

A & S ENGINEERS INC. Mechanical, Electrical & Plumbing Consultants 175 LENNON LANE, SUITE 205 WALNUT CREEK, CA 94598 TEL: 925-937-6700 | WEB : http://www.asincs.co

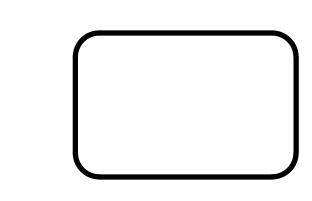








SEALS AND SIGNATURES



ISSUE SCHEDULE	NO.	DATE
PLAN REVIEW SUBMITTAL V1		12/30/202
PLAN REVIEW SUBMITTAL V2		02/03/202
KEY PLAN	١	

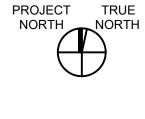


LOS MEDANOS COLLEGE

COMMUNITY ROOM & CONFERENCE ROOM

SHEET TITLE:

ELECT. SYMBOLS, LEGENDS, ABBREV., & GENERAL NOTES


AS SHOWN PROJECT NUMBER: 01-119293

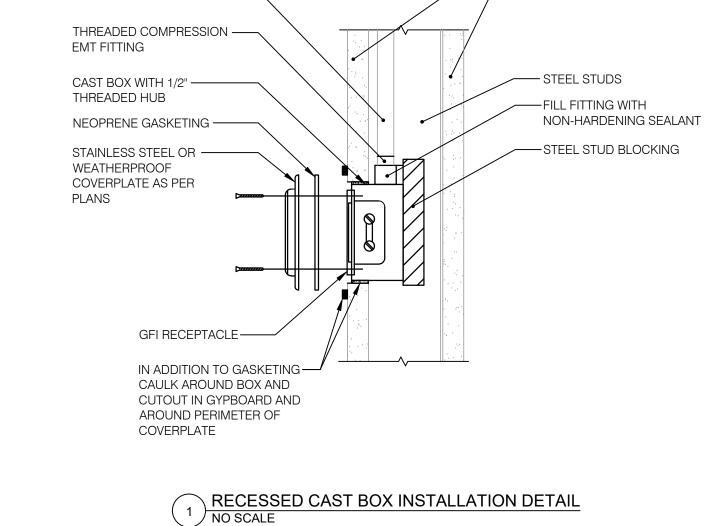


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EMT CONDUIT —


**AV UPGRADES** 



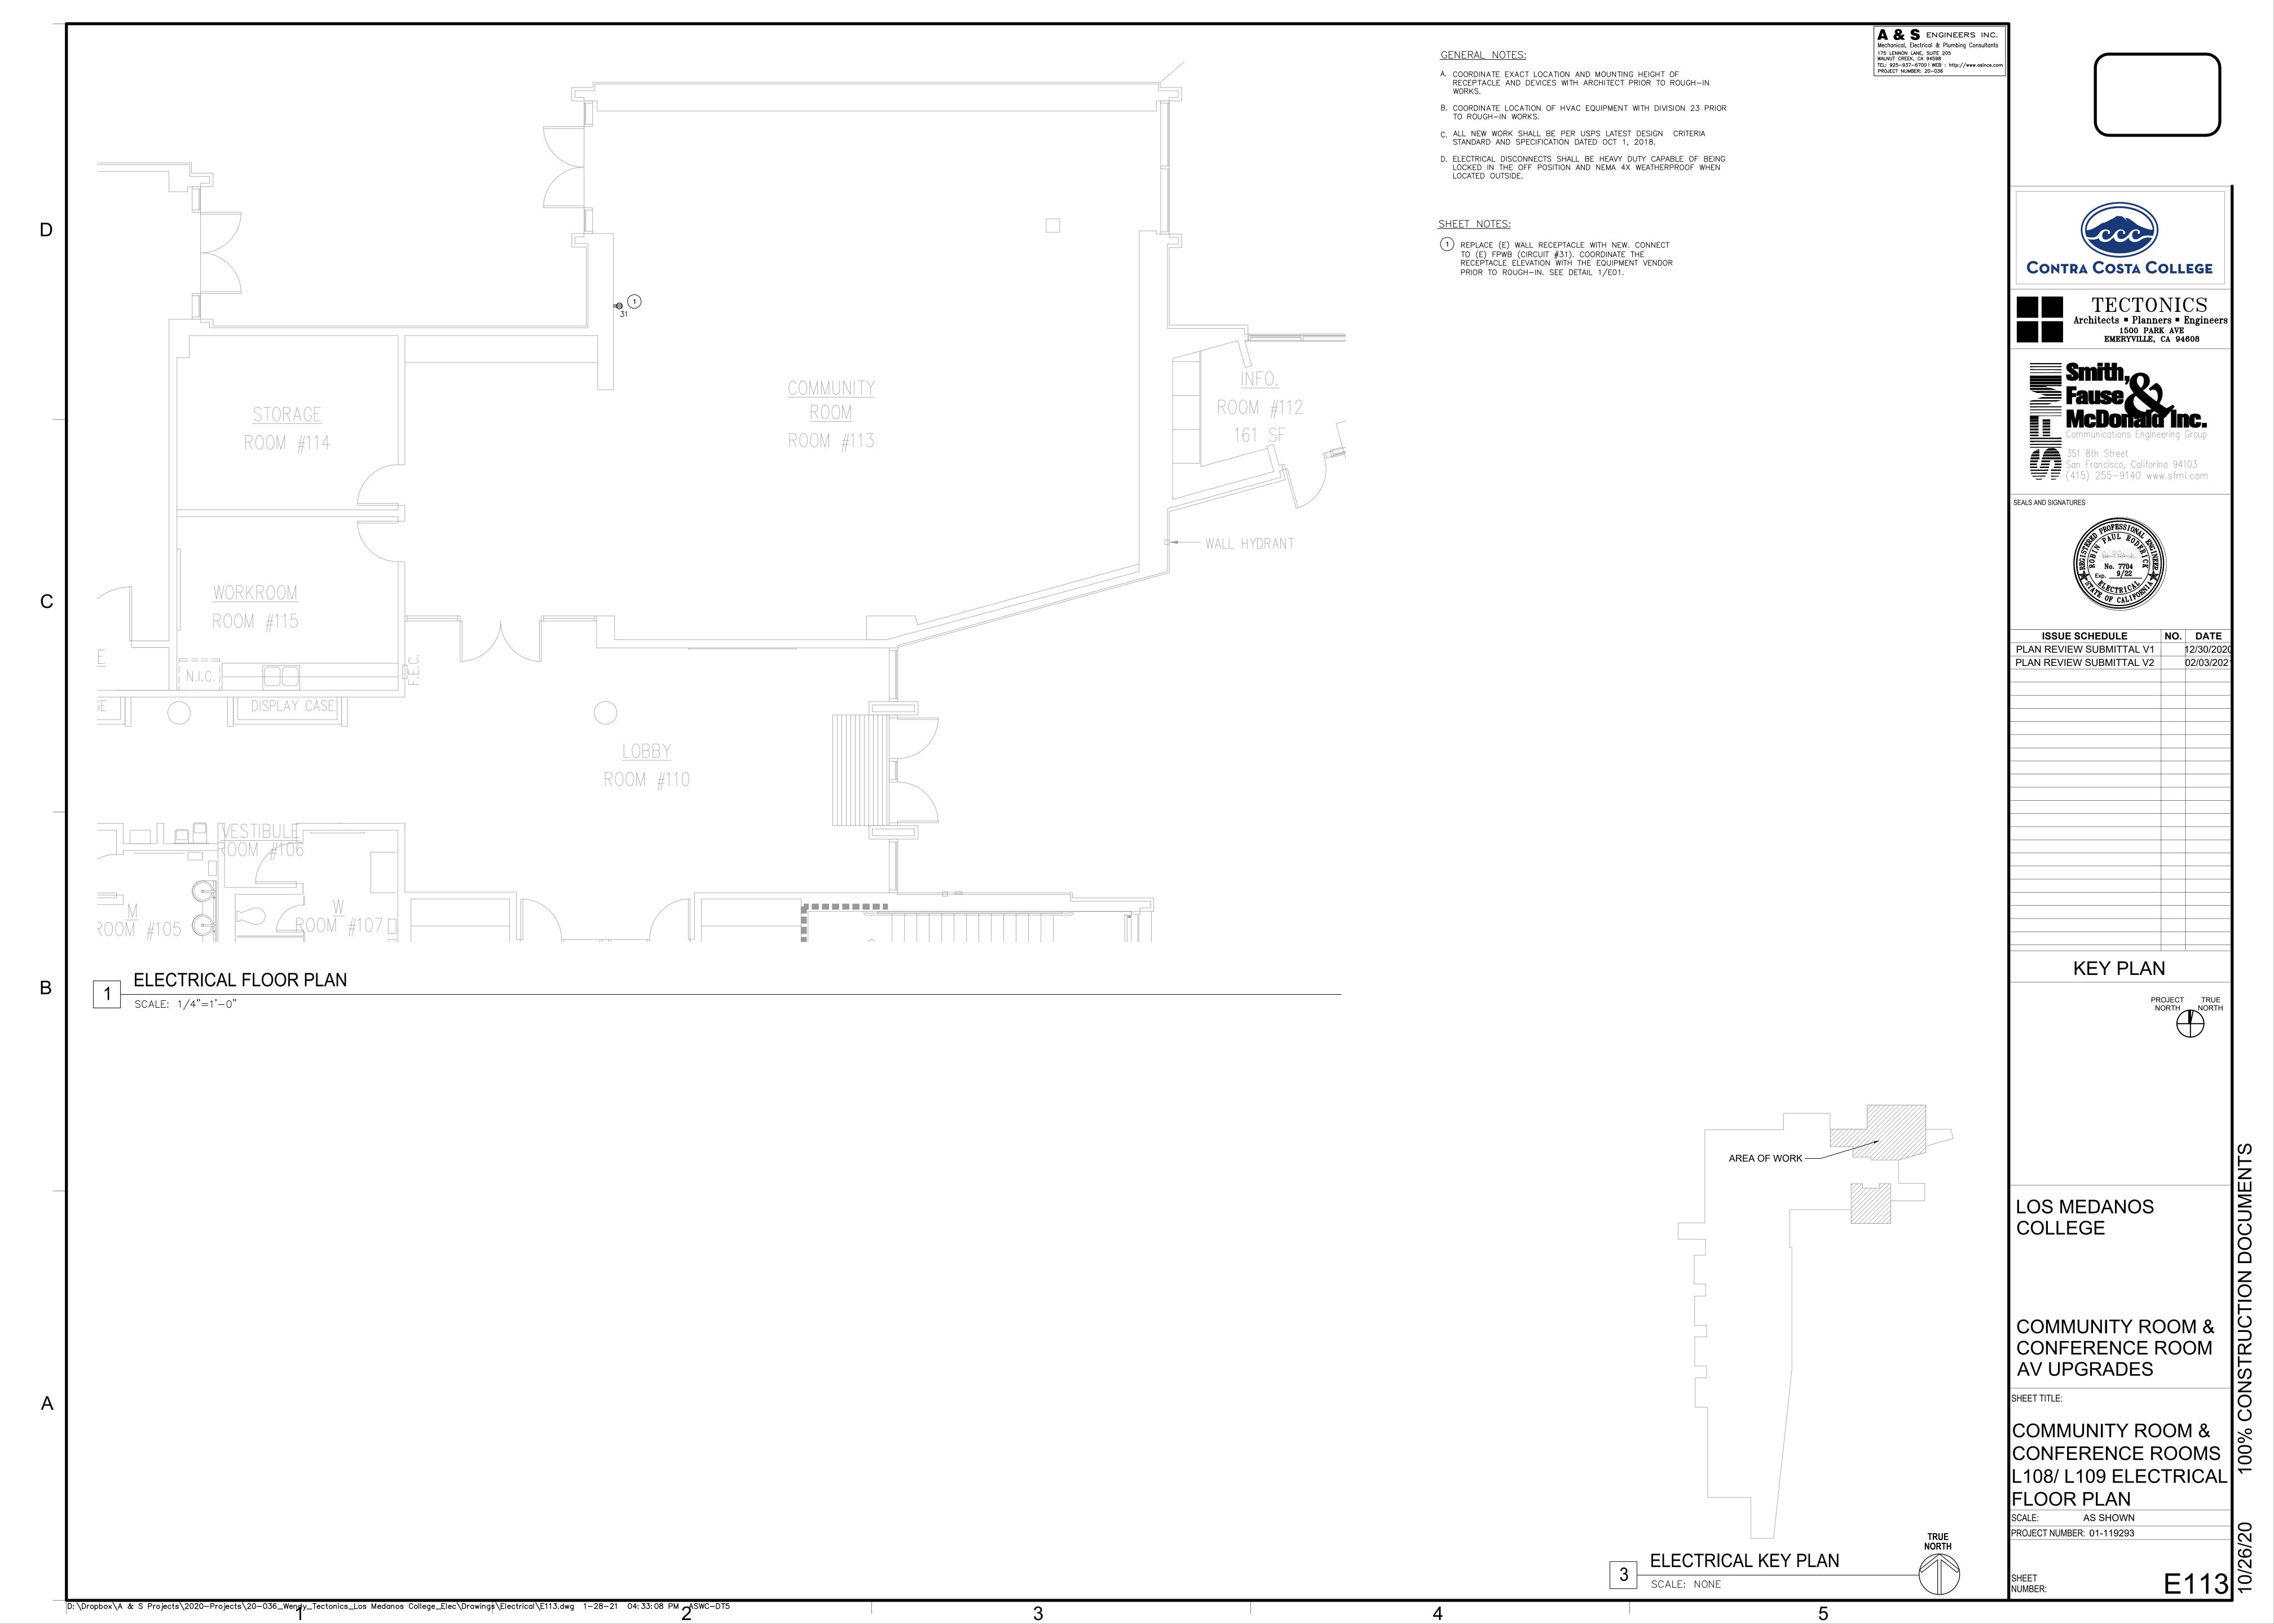


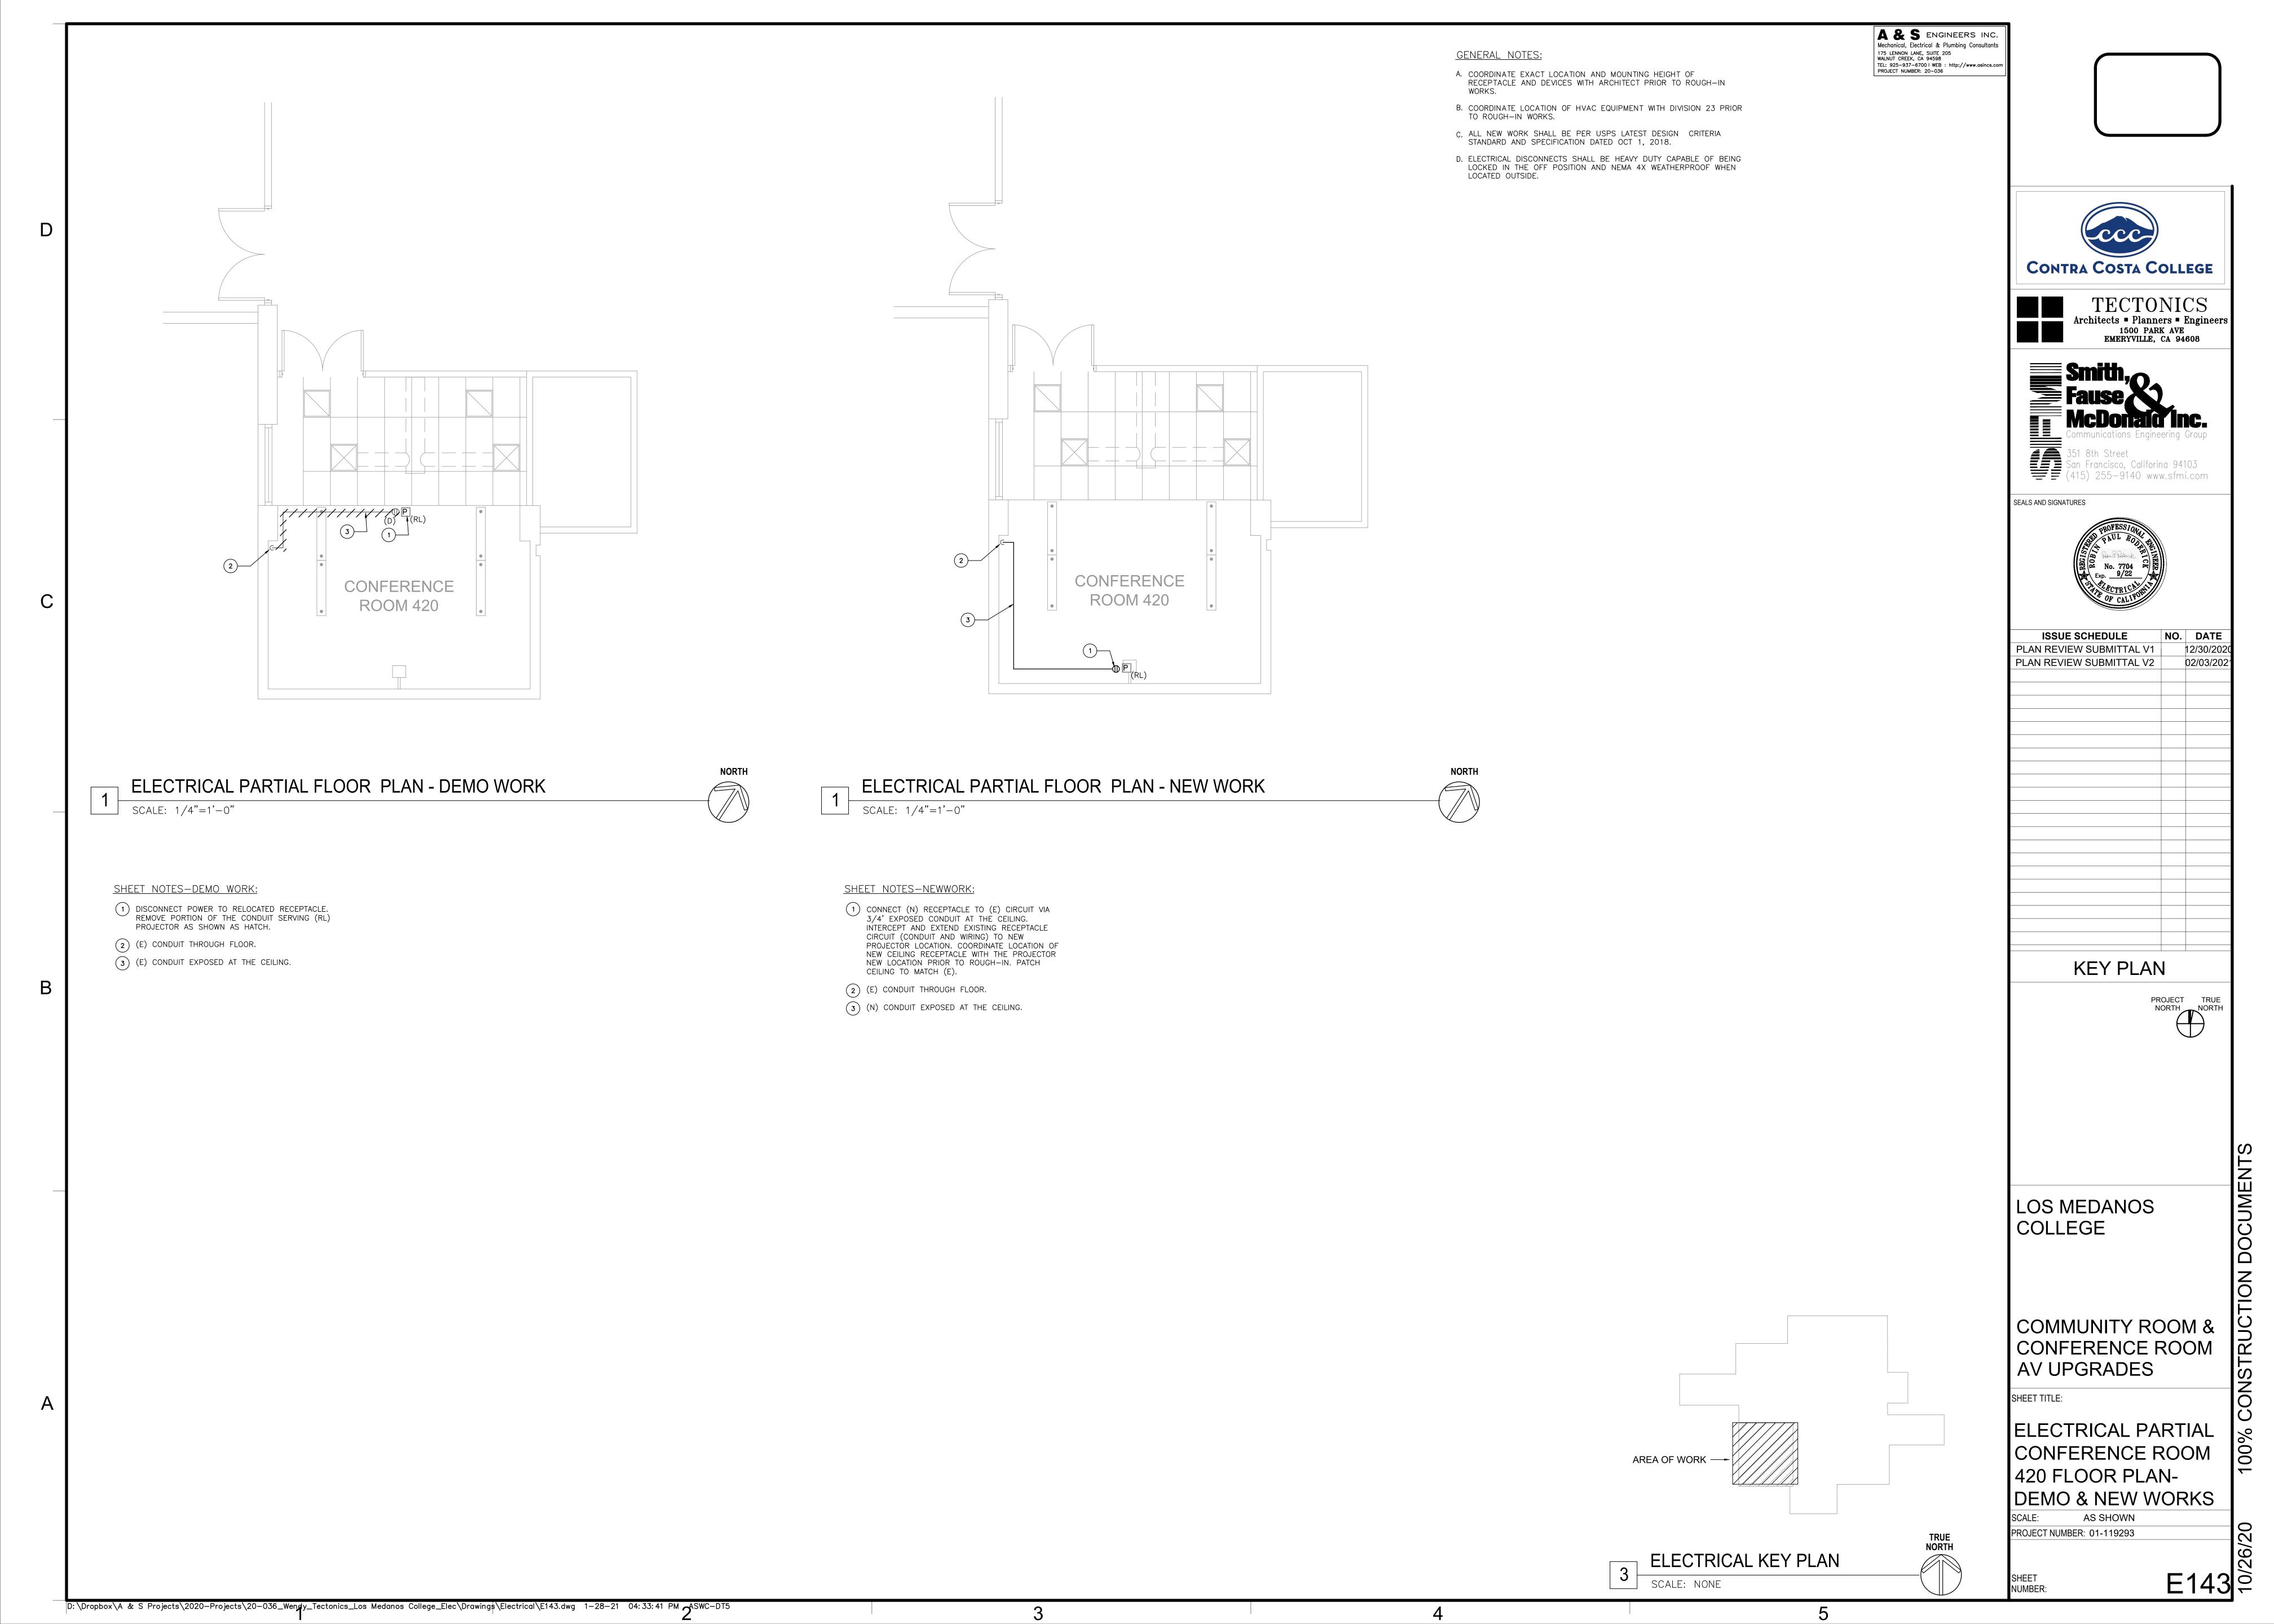- 1. REFER TO SPECIFICATIONS FOR COMPLETE REQUIREMENTS.
- 2. PROVIDE CONDUIT, BOXES AND FITTINGS SHOWN ON AUDIO VISUAL SYSTEMS (AV) DRAWINGS UNDER THE WORK OF SECTION 27 05 33 COMMUNICATIONS RACEWAYS, BOXES AND FITTINGS. UNLESS OTHERWISE INDICATED, PROVIDE 1 INCH TRADE SIZE MINIMUM. PROVIDE RACEWAY SIZE AS REQUIRED FOR A MAXIMUM OF 30 PERCENT WIRE FILL.
- 3. PROVIDE FIRESTOPPING UNDER THE WORK OF SECTION 27 05 33.
- 4. LOCATIONS SHOWN ON THE ARCHITECTURAL DRAWINGS TAKE PRECEDENCE OVER LOCATIONS SHOWN ON THE COMMUNICATIONS SYSTEMS DRAWINGS.
- 5. DEVICE QUANTITIES SHOWN ON FLOOR PLANS AND REFLECTED CEILING PLANS TAKE PRECEDENCE OVER DEVICE QUANTITIES SHOWN ON FUNCTIONAL DIAGRAMS.
- 6. QUANTITIES SHOWN ON FUNCTIONAL DIAGRAMS TAKE PRECEDENCE OVER QUANTITIES SHOWN ON RACK ELEVATIONS.
- 7. QUANTITIES SHOWN ON DEVICE SCHEDULES TAKE PRECEDENCE OVER QUANTITIES SHOWN ON FUNCTIONAL DIAGRAMS, FLOOR PLANS AND REFLECTED CEILING PLANS.
- 8. LOCATIONS SHOWN ON LARGE SCALE DRAWINGS TAKE PRECEDENCE OVER LOCATIONS SHOWN ON SMALL SCALE DRAWINGS.
- 9. NOT USED.
- 10. WIRING FOR THE WORK OF AUDIO VISUAL SYSTEMS IS NOT PERMITTED TO SHARE CONDUIT, SLEEVES OR J-HOOKS WITH WIRING FOR WORK OF COMMUNICATIONS WIRES, CABLES AND RELATED. MAINTAIN AT LEAST 2 INCHES SEPARATION IF RUNNING PARALLEL. MAINTAIN AT LEAST 1 INCH OF SEPARATION VERTICALLY IF CROSSING AT RIGHT ANGLES.

### LEGEND

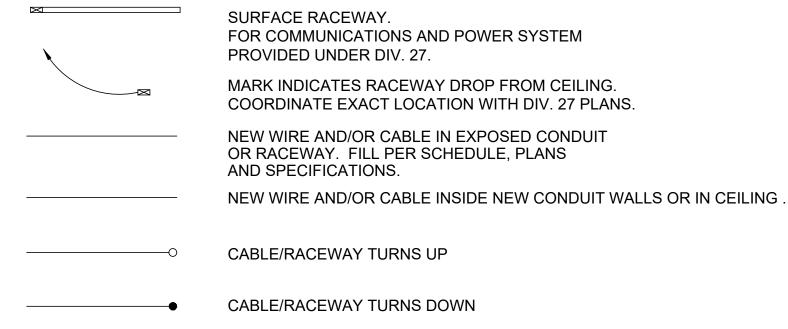

### GENERAL SYMBOLS

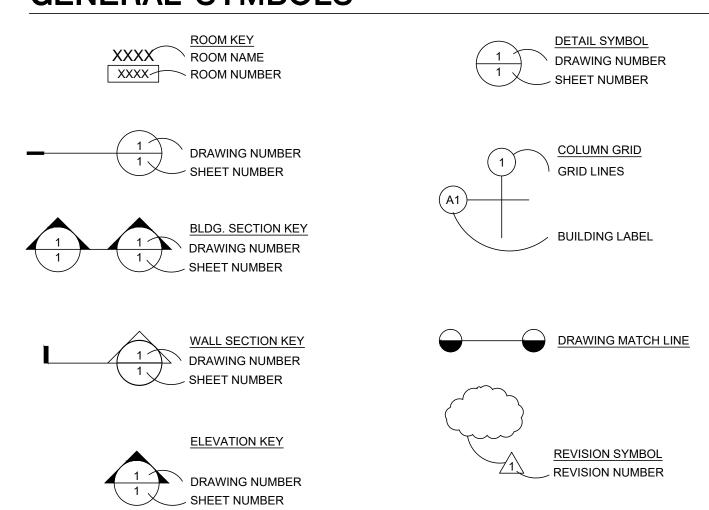

### **ALS SCHEDULE**

4 SIGNAGE: PROVIDE UNDER WORK OF SECTION 10 14 00.

COMPLY WITH CBC 1104B.2 ASSISTIVE-LISTENING SYSTEMS IN ASSEMBLY AREAS. PROVIDE COMPLETE ASSISTIVE-LISTENING SYSTEMS UNDER THE WORK OF SECTION 27 41 16.

ROOM NAME/TYPE	TOTAL OCCUPANCY
Community Room	99
Conference #1	24
Conference #2	24
Conference 409	28
Conference 420	22
TOTAL OCCUPANCY AT ALS-REQUIRED SPACES:	197
PROVIDE QUANTITY OF RECEIVERS:	8
PROVIDE QUANTITY OF HEARING-AID COMPATIBLE NECK LOOPS:	2
TYPE OF LISTENING SYSTEM: PERMANENT RF or IR	

### AV FUNCTIONALS LEGEND

AV FUN	NCTIONALS LEGEND		
Loudspeaker ty and Specificati		RR	REPEAT RELAY
	SHB4 2	——————————————————————————————————————	XLR CONNECTOR, 3 PIN, FEMALE; MALE XLR CONNECTOR, 4 PIN, FEMALE; MALE AUDIO SPEAKER CONNECTOR, FEMALE; MALE
ВМ	TRANSFORMER BALANCED, LINE INPUT MODULE, PRIORITY MUTE GENERATING		BNC CONNECTOR, 75 OHMS IMPEDANCE DIN CONNECTOR, MIDI STANDARD
МВІ	TRANSFORMER BALANCED, MIC INPUT MODULE, PRIORITY MUTE GENERATING	—P	1/4" PHONE CONNECTOR
VBI	TRANSFORMER BALANCED, LINE INPUT MODULE, PRIORITY MUTE RECEIVING, ADJUSTABLE MUTE LEVEL	<del></del>	TRIPLE FIVE WAY BINDING POSTS
К	RELAY COIL	—⊙ — <b>≼</b>	TYPE "F" CONNECTOR  RESISTIVE TERMINATION AT CIRCUIT
(VC-R)	70 WATT PRIORITY ATTENUATOR, RACK MOUNTED	•	CHARACTERISTIC IMPEDANCE
<del></del>	PUSH BUTTON SWITCH	<b>→</b>	WIRING CONTINUES AS INDICATED WIRING HOME RUN AS INDICATED
<u> </u>	MOMENTARY PUSH BUTTON SWITCH	*	FLY-ON OR FLY-OFF POINT
•••	SWITCH	<b></b>	TUBULAR CLAMP BARRIER BLOCK, SWITCH BLOCK SECTION QUANTITY AS REQUIRED BY CIRCUIT
•	SWITCH	—(SVM) —(SVF)	S-VIDEO CONNECTOR, MALE; FEMALE
$\dashv\vdash$	NORMALLY OPEN CONTACT	——RF ——RM	TYPE RCA AUDIO OR VIDEO CONNECTOR, FEMALE; MALE
#	NORMALLY CLOSED CONTACT	— <b>◎</b> —(MF) —(MM)	SCREW TERMINAL  TRS MINI STEREO AUDIO CONNECTOR, FEMALE; MALE.
NOTES:			

### **ABBREVIATIONS**

A.F.F. ALT	AMERICANS WITH DISABILITIES ACT ABOVE FINISHED CEILING ABOVE FINISHED FLOOR ALTERNATE ABOVE MEZZANINE FINISHED FLOOR BUILDING DISTRIBUTION FACILITY BELOW FINISHED CEILING BUILDING BACK OF HOUSE CONDUIT CATEGORY CALIFORNIA BUILDING CODE	MMF MOD. MPOE (N) NEC N.I.C. NTS O.C. O.D. O.F.E. OSP	MULTI MODE OPTICAL FIBER MODULAR MINIMUM POINT OF ENTRY NEW NATIONAL ELECTRICAL CODE NOT IN CONTRACT NOT TO SCALE ON CENTER OUTSIDE DIAMETER OWNER FURNISHED EQUIPMENT OPPOSITE OUTSIDE PLANT
C.L.	CENTERLINE	PROJ. P.S.R.H	PROJECT PROJECT STANDARD RECEPTACLE HEIGHT +18" ATT, U.O.
C.O.	CONDUIT ONLY		PROJECT STANDARD SWITCH HEIGHT +48" AFF TO \$\varphi\$ U.O.N
CONT.	CONTINUATION	RE:	REFER TO
CS	COMMUNICATIONS SYSTEM	REF.	REFERENCE
(D)	DEMOLISH EXISTING	S.A.D.	SEE ARCHITECTURAL DRAWINGS
DED	DEDUCTIVE	S.E.D.	SEE ELECTRICAL DRAWINGS
DIA.	DIAMETER	S.I.D.	SEE INTERIORS DRAWINGS
DIV	DIVISION	S.M.D.	SEE MECHANICAL DRAWINGS
(E)	EXISTING	SIM.	SIMILAR
EA.	EACH	SMF	SINGLE MODE OPTICAL FIBER
EIA	ELECTRONIC INDUSTRIES ASSOCIATION	SN	SHEET NOTE
ELEV.	ELEVATION	SP	SHIELDED PAIR - SEE SPECIFICATIONS
E.O.L.	END OF LINE	SPEC	SPECIFICATION
EQPT.	EQUIPMENT	S.R.	SURFACE RACEWAY
FIN	FINISHED	STD	STANDARD
FUT	FUTURE	STP	SHIELDED TWISTED PAIR
H.R.	HOME RUN	T.C.	TELECOMMUNICATIONS CLOSET
HT. IDF	HEIGHT INTERMEDIATE DISTRIBUTION FACILITY	TEL	TELEPHONE
J, JBOX	JUNCTION BOX		TELECOMMUNICATIONS TELECOMMUNICATIONS INDUSTRY ASSOCIATION
LAN	LOCAL AREA NETWORK	TIA	TELECOMMUNICATIONS INDUSTRY ASSOCIATION
MAX.	MAXIMUM	TP TVD	TWISTED PAIR
MDF	MAIN DISTRIBUTION FACILITY	TYP. U.O.N.	TYPICAL UNLESS OTHERWISE NOTED
MIN.	MINIMUM		
		۱۸//	\//ITLI

WEATHERPROOF


### JUNCTION BOX SCHEDULE

SYMBOL	H (INCHES)	W (INCHES)	D (INCHES
J1	6	6	4
J2	8	8	4
J3	12	12	4
J4	12	12	6
J5	12	12	8
J6	16	12	8
J7	18	18	6
J8	20	16	6
J9	20	16	8
J10	20	20	6
J11	20	20	8
J12	24	20	6
J13	24	20	8
J14	24	24	8
J15	30	24	8
J16	30	30	8
J17	36	30	8
J18	36	36	8

NONE - NEMA 1 ALL JUNCTION BOXES TO BE HINGED TYPE, PROVIDED WITHOUT PRE-PUNCHED KNOCKOUTS. PENETRATIONS IN JUNCTION BOXES SHALL BE CUT OR PUNCHED AS REQUIRED FOR INSTALLATION. PAINT ALL INTERIOR BOXES TO MATCH WALL FINISH. COORDINATE FINISH

WITH ARCH. PLANS.



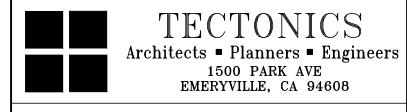



SEALS AND SIGNATURES

ISSUE SCHEDULE	NO.	DAT
PLAN REVIEW SUBMITTAL V1		12/30/2
PLAN REVIEW SUBMITTAL V2		02/03/2
KEY PLA	N	

LOS MEDANOS COLLEGE

COMMUNITY ROOM & CONFERENCE ROOM **AV UPGRADES** 

SHEET TITLE:

GENERAL NOTES, LEGEND, SYMBOL, ABBREV., JBOX & ALS SCHEDULES AS SHOWN

PROJECT NUMBER: 01-119293

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HOME RUN

WIRING NOTES (TKA1) KEYNOTES

X DE<del>NO</del>TES SEQUENCE NUMBER

TA-001 1979

SYMBOL	DEVICE	FUNCTION OR SERVICE	LOCATION	WORK OF	ROUGH-IN	RACEWAY	ELEVATION	CABLE FILL &	FINISH	WEIGHT,	DETAIL QUEET(Q)
STIVIBOL	DEVICE	FUNCTION OR SERVICE	LOCATION	WORK OF	KOUGH-IIN	RACEVVAT	ELEVATION	HOMERUN DESTINATION, U.O.N.	FINISH	LB	DETAIL SHEET(S)
A	ASSISTIVE LISTENING TRANSMITTER	AUDIO VISUAL	CEILING	27 41 16	FLUSH 4S BOX, 1 G. RING.	R6	SURFACE MOUNT TO CEILING	SERVING IDF AV RACK	WHITE	1	N/A
ВМІС	BOUNDARY MICROPHONE ARRAY	AUDIO VISUAL	CONFERENCE TABLE	27 41 16	N/A	N/A	TABLE SURFACE	UMBILICAL TO FLOORBOX BELOW	BLACK	N/A	N/A
НСВР	CONTROL BUTTON PANEL, WALL MOUNTED	AUDIO VISUAL	WALL	27 41 16	AT EXISTING CONTROL BUTTON PANEL LOCATION	R6	AT EXISTING CONTROL BUTTON PANEL LOCATION	PER FUNCTIONAL AND AS NOTED	WHITE	N/A	N/A
CCAM	USB CONFERENCING CAMERA	AUDIO VISUAL	WALL	27 41 16	FLUSH 4S BOX, 1 G. RING.	R6	+84" A.F.F., U.O.N.	PER FUNCTIONAL AND AS NOTED	WHITE	7	N/A
CM	CEILING MICROPHONE ARRAY	AUDIO VISUAL	CEILING	27 41 16	MFG. CEILING MOUNT KIT	R6	CEILING	PER FUNCTIONAL AND AS NOTED	WHITE	5	
CONFSBS	INTEGRATED CONFERENCING CAMERA/MICROPHONE/SOUNDBAR	AUDIO VISUAL	SET/WALL ATTACHED	27 41 16	N/A	N/A	BELOW FLAT PANEL DISPLAY	PER FUNCTIONAL AND AS NOTED	BLACK	12	N/A
СТР	AV CONTROL TOUCH PANEL, TOPSET	AUDIO VISUAL	CONFERENCE TABLE	27 41 16	FLUSH 2G BOX, W/ 2G. RING.	R6	+40" A.F.F. TO CL, U.O.N.	UMBILICAL TO FLOORBOX BELOW	WHITE	2	N/A
Н <u>стw</u>	AV CONTROL TOUCH PANEL, WALL MOUNTED	AUDIO VISUAL	WALL	27 41 16	FLUSH 2G BOX, W/ 2G. RING.	R6	+40" A.F.F. TO CL, U.O.N.	PER FUNCTIONAL AND AS NOTED	WHITE	2	N/A
FC6 (E)	FLOOR BOX, (EXISTING)	COMMUNICATIONS & AUDIO-VISUAL	FLOOR (E)	27 05 33	EXISTING	N/A	FLUSH IN FLOOR	AS SCHEDULED	ALUMINUM OR BRUSHED SS EXPOSED TRIM. COORDINATE CARPET CUT AND INSERT.	N/A	N/A
FPWB	FLAT PANEL ROUGH-IN BOX (E)	AUDIO VISUAL	FLUSH IN WALL – (E)	27 05 33	EXISTING	N/A	SEE DISPLAY ELEVATION, CENTERLINE OF FPWB TO MATCH CENTERLINE OF DISPLAY	AS SCHEDULED	WHITE	10	TA-901
LCD23	FLAT PANEL DISPLAY, 23" DIAGONAL CLASS, TOPSET/PANEL MOUNT	AUDIO VISUAL	PRESENTATION LECTERN/RACK R33	27 41 16	N/A	N/A	PRESENTATION LECTERN/RACK PANEL	N/A	BLACK	20	N/A
LCD70	FLAT PANEL DISPLAY, 70" DIAGONAL CLASS	AUDIO VISUAL	WALL	27 41 16	FPWB	SEE FPWB	+80" A.F.F. TO UNDERSIDE	N/A	BLACK	145	TA-901
LCD80	FLAT PANEL DISPLAY, 80" DIAGONAL CLASS	AUDIO VISUAL	WALL	27 41 16	FPWB	SEE FPWB	+65" A.F.F. TO CENTERLINE	N/A	BLACK	175	TA-901
MP1	MEDIA INPUT PANEL,HDMI-4K	AUDIO VISUAL	WALL/FLOORBOX	27 41 16	AT WALL: 2-3/4" DEEP 1G BOX W/ RING, IN FLOORBOX: 1G PLATE	R6	+40" A.F.F. TO CL, U.O.N.	PER FUNCTIONAL AND AS NOTED	WHITE	N/A	N/A
MP2	MEDIA INPUT PANEL, RJ45	AUDIO VISUAL	FLOORBOX	27 41 16	1G PLATE IN FLOORBOX (MULTIPLE RJ45 JACKS SHOWN ON ROOM FUNCTIONAL DIAGRAMS MAYBE COMBINED ONTO A SINGLE PLATE	R6	+40" A.F.F. TO CL, U.O.N.	PER FUNCTIONAL AND AS NOTED	WHITE	N/A	N/A
R18	SLIDE-OUT/PIVOT UNDERCOUNTER AV EQUIPMENT RACK	AUDIO VISUAL	INDICATED	27 11 16	PROPRIETARY MANUFACTURER BACKBOX.	(4) 2" C. FROM REAR OF RACK TO ABOVE ACCESSIBLE CEILING	IN CASEWORK	PER FUNCTIONAL AND AS NOTED	BLACK	50	TA902
R33 (E)	4-POST AV EQUIPMENT RACK (EXISTING)	AUDIO VISUAL	INDICATED	27 11 16	N/A	(E) CONDUITS AND PATHWAY TO COMMUNITY ROOM EQUIPMENT TO BE RE-USED WHERE POSSIBLE.	FLOOR	PER FUNCTIONAL AND AS NOTED	BLACK	400	TA903
SA	LOUDSPEAKER, FLUSH-MOUNT, CEILING	AUDIO VISUAL	FLUSH IN FINISHED CEILING	27 41 16	PROPRIETARY MANUFACTURER BACKBOX.	R6	CEILING	PER FUNCTIONAL AND AS NOTED	WHITE	10.4	N/A
HSP	LOUDSPEAKER, SURFACE-MOUNT, WALL	AUDIO VISUAL	WALL	27 41 16	PROVIDE ONE (1) 5" SQUARE x 2.875" DEEP BOX WITH TWO (2) GANG RING EQUAL TO RANDL INDUSTRIES 5 SQUARE. www.randl-inc.com	R5	+80" A.F.F. TO UNDERSIDE	PER FUNCTIONAL AND AS NOTED	WHITE	12	N/A
• VPROJ	VIDEO PROJECTOR, CEILING MOUNT. REFER TO ENLARGED PLANS.	AUDIO VISUAL	INDICATED	27 41 16	REUSE EXISTING CEILING/POLE MOUNT	R2	AS DETAILED - ALIGN TOP OF PROJECTOR LENS LEVEL WITH TOP OF VIEWABLE AREA OF PROJECTION SCREEN.	PER FUNCTIONAL AND AS NOTED	WHITE	50	TA902
VPROJ1	SHORT-THROW WALL MOUNT VIDEO PROJECTOR	AUDIO VISUAL	INDICATED	27 41 16	PROPRIETARY MANUFACTURER MOUNTING PLATE, S.A.D. FOR MOUNTING HARDWARE REQUIREMENTS	PROVIDE SURFACE-MOUNT RACEWAY FROM PROJECTOR MOUNT LOCATION TO R18.	MOUNT PROJECTOR TO ALIGN WITH VIEWABLE AREA OF PROJECTABLE WHITE-BOARD SURFACE BELOW, S.A.D. FOR WHITEBOARD DETAILS/ELEVATIONS.	PER FUNCTIONAL AND AS NOTED	WHITE	40	N/A
WMIC	WIRELESS MICROPHONE	AUDIO VISUAL	INDICATED	27 41 16	FLUSH 4S BOX, 1 G. RING.	R6	CEILING	PER FUNCTIONAL AND AS NOTED	WHITE	N/A	N/A
NOTE NO.	WORK OF NOTES					R1	RACEWAY NOTES 2" C. EXTEND TO ACCESSIBL	E CEII ING			

**LOCATION & ROUGH-IN NOTES** INSTALLED ASSEMBLY, INCLUDING MONITOR SHALL NOT PROJECT MORE THAN 4" FROM FACE OF WALL.

MATCH PROJECT SWITCH HEIGHT

4S BOX W/ 1 GANG RING BLANK COVER PLATE

NOT USED

NOT USED

MANUFACTURER'S VENTED BACKBOX NOT USED

4S BOX, 2-1/8" DEEP MIN., W/ 1 GANG RING WITH LOCKING HINGED COVER PLATE (FSR WB-MR2G OR EQUAL).

NOT USED

LRI10 PROVIDE BACKING AND SUPPORT FOR 5 POUND DEVICE.

LRI11 PROVIDE DEVICE COMPLETE WITH BACKBOX, TILE SUPPORT RAILS AND CEILING CUTOUT TEMPLATE. COMPLY WITH

LRI12 SECTION 09 50 11 ACOUSTICAL PANEL CEILINGS.

PROVIDE BACKING IN WALL SUITABLE TO SUPPORT A 20 POUND DEVICE WITH A LOAD CENTROID 18 INCHES FROM THE LRI13 FACE OF THE WALL.

PROVIDE BACKING IN WALL SUITABLE TO SUPPORT A 200 POUND DEVICE WITH A LOAD CENTROID 8 INCHES FROM THE FACE OF THE WALL.

AS DETAILED AND/OR SCHEDULED ON THE ARCHITECTURAL DRAWINGS.

2" C. EXTEND TO ACCESSIBLE CEILING

2" C. H.R. TO AV EQUIPMENT RACK

NOT USED

AS DETAILED AND/OR SCHEDULED

3/4" C. H.R. TO ACCESSIBLE CEILING OR FLOOR, OR TO SERVING BDF, IDF OR EQUIPMENT ROOM, U.O.N.

1" C. H.R. TO ACCESSIBLE CEILING OR FLOOR, OR TO SERVING BDF, IDF OR EQUIPMENT ROOM, U.O.N. 1-1/4" C. H.R. TO ACCESSIBLE CEILING OR FLOOR, OR TO SERVING BDF, IDF OR EQUIPMENT ROOM, U.O.N.

AT ACCESSIBLE CEILING, PROVIDE ABOVE CEILING PATHWAY USING CABLE HOOKS. WHERE MOUNTED IN GYP CEILING,

EXTEND 3/4" C. TO ACCESSIBLE CEILING.


2 1-1/4" C TO 4 GANG COMPARTMENT, 1 - 1" TO 1 GANG COMPARTMENT, STUBBED TO ACCESSIBLE CEILING OR FLOOR. SEE ELECTRICAL DRAWINGS FOR ELECTRICAL ROUGH-IN.

UNLESS OTHERWISE SHOWN, PROVIDE 1.5" EMT SLEEVE, WITH INSULATED THROAT BUSHING AT EACH END, STUBBED OUT 4 INCHES FROM FACE OF WALL, AT ELEVATION APPROXIMATELY 6 INCHES ABOVE ACCESSIBLE CEILING. INSTALL SLEEVE IN

AN ACCESSIBLE LOCATION AS DEFINED IN CALIFORNIA ELECTRICAL CODE, ARTICLE 100 DEFINITIONS. PROVIDE FIRESTOPPING UNDER WORK OF SECTION 27 05 33. BOND TO GROUND. COMPLY WITH DIVISION 26 AND SECTION 27 05 26 GROUNDING.

4 1-1/4" C TO 6 GANG COMPARTMENT, 1 - 1.25" TO EA. 1 GANG COMPARTMENT, STUBBED TO ACCESSIBLE CEILING OR FLOOR, EXTEND TO SERVER ROOM IN BASKET TRAY. SEE ELECTRICAL DRAWINGS FOR ELECTRICAL ROUGH-IN TO 3 GANG COMPARTMENT.

ACCESSIBLE CEILING IS A T-BAR OR SIMILAR GRID BASED, PANELIZED REMOVEABLE CEILING MEETING THE DEFINITION FOR ACCESSIBLE WIRING METHODS IN ARTICLE 100 OF THE CALIFORNIA ELECTRICAL CODE.

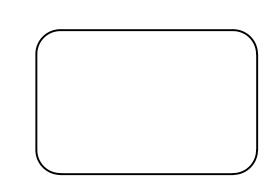







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SEALS AND SIGNATURES

ISSUE SCHEDULE	NO.	DA
PLAN REVIEW SUBMITTAL V1		12/30
PLAN REVIEW SUBMITTAL V2		02/03

### KEY PLAN

LOS MEDANOS COLLEGE

COMMUNITY ROOM & CONFERENCE ROOM **AV UPGRADES** 


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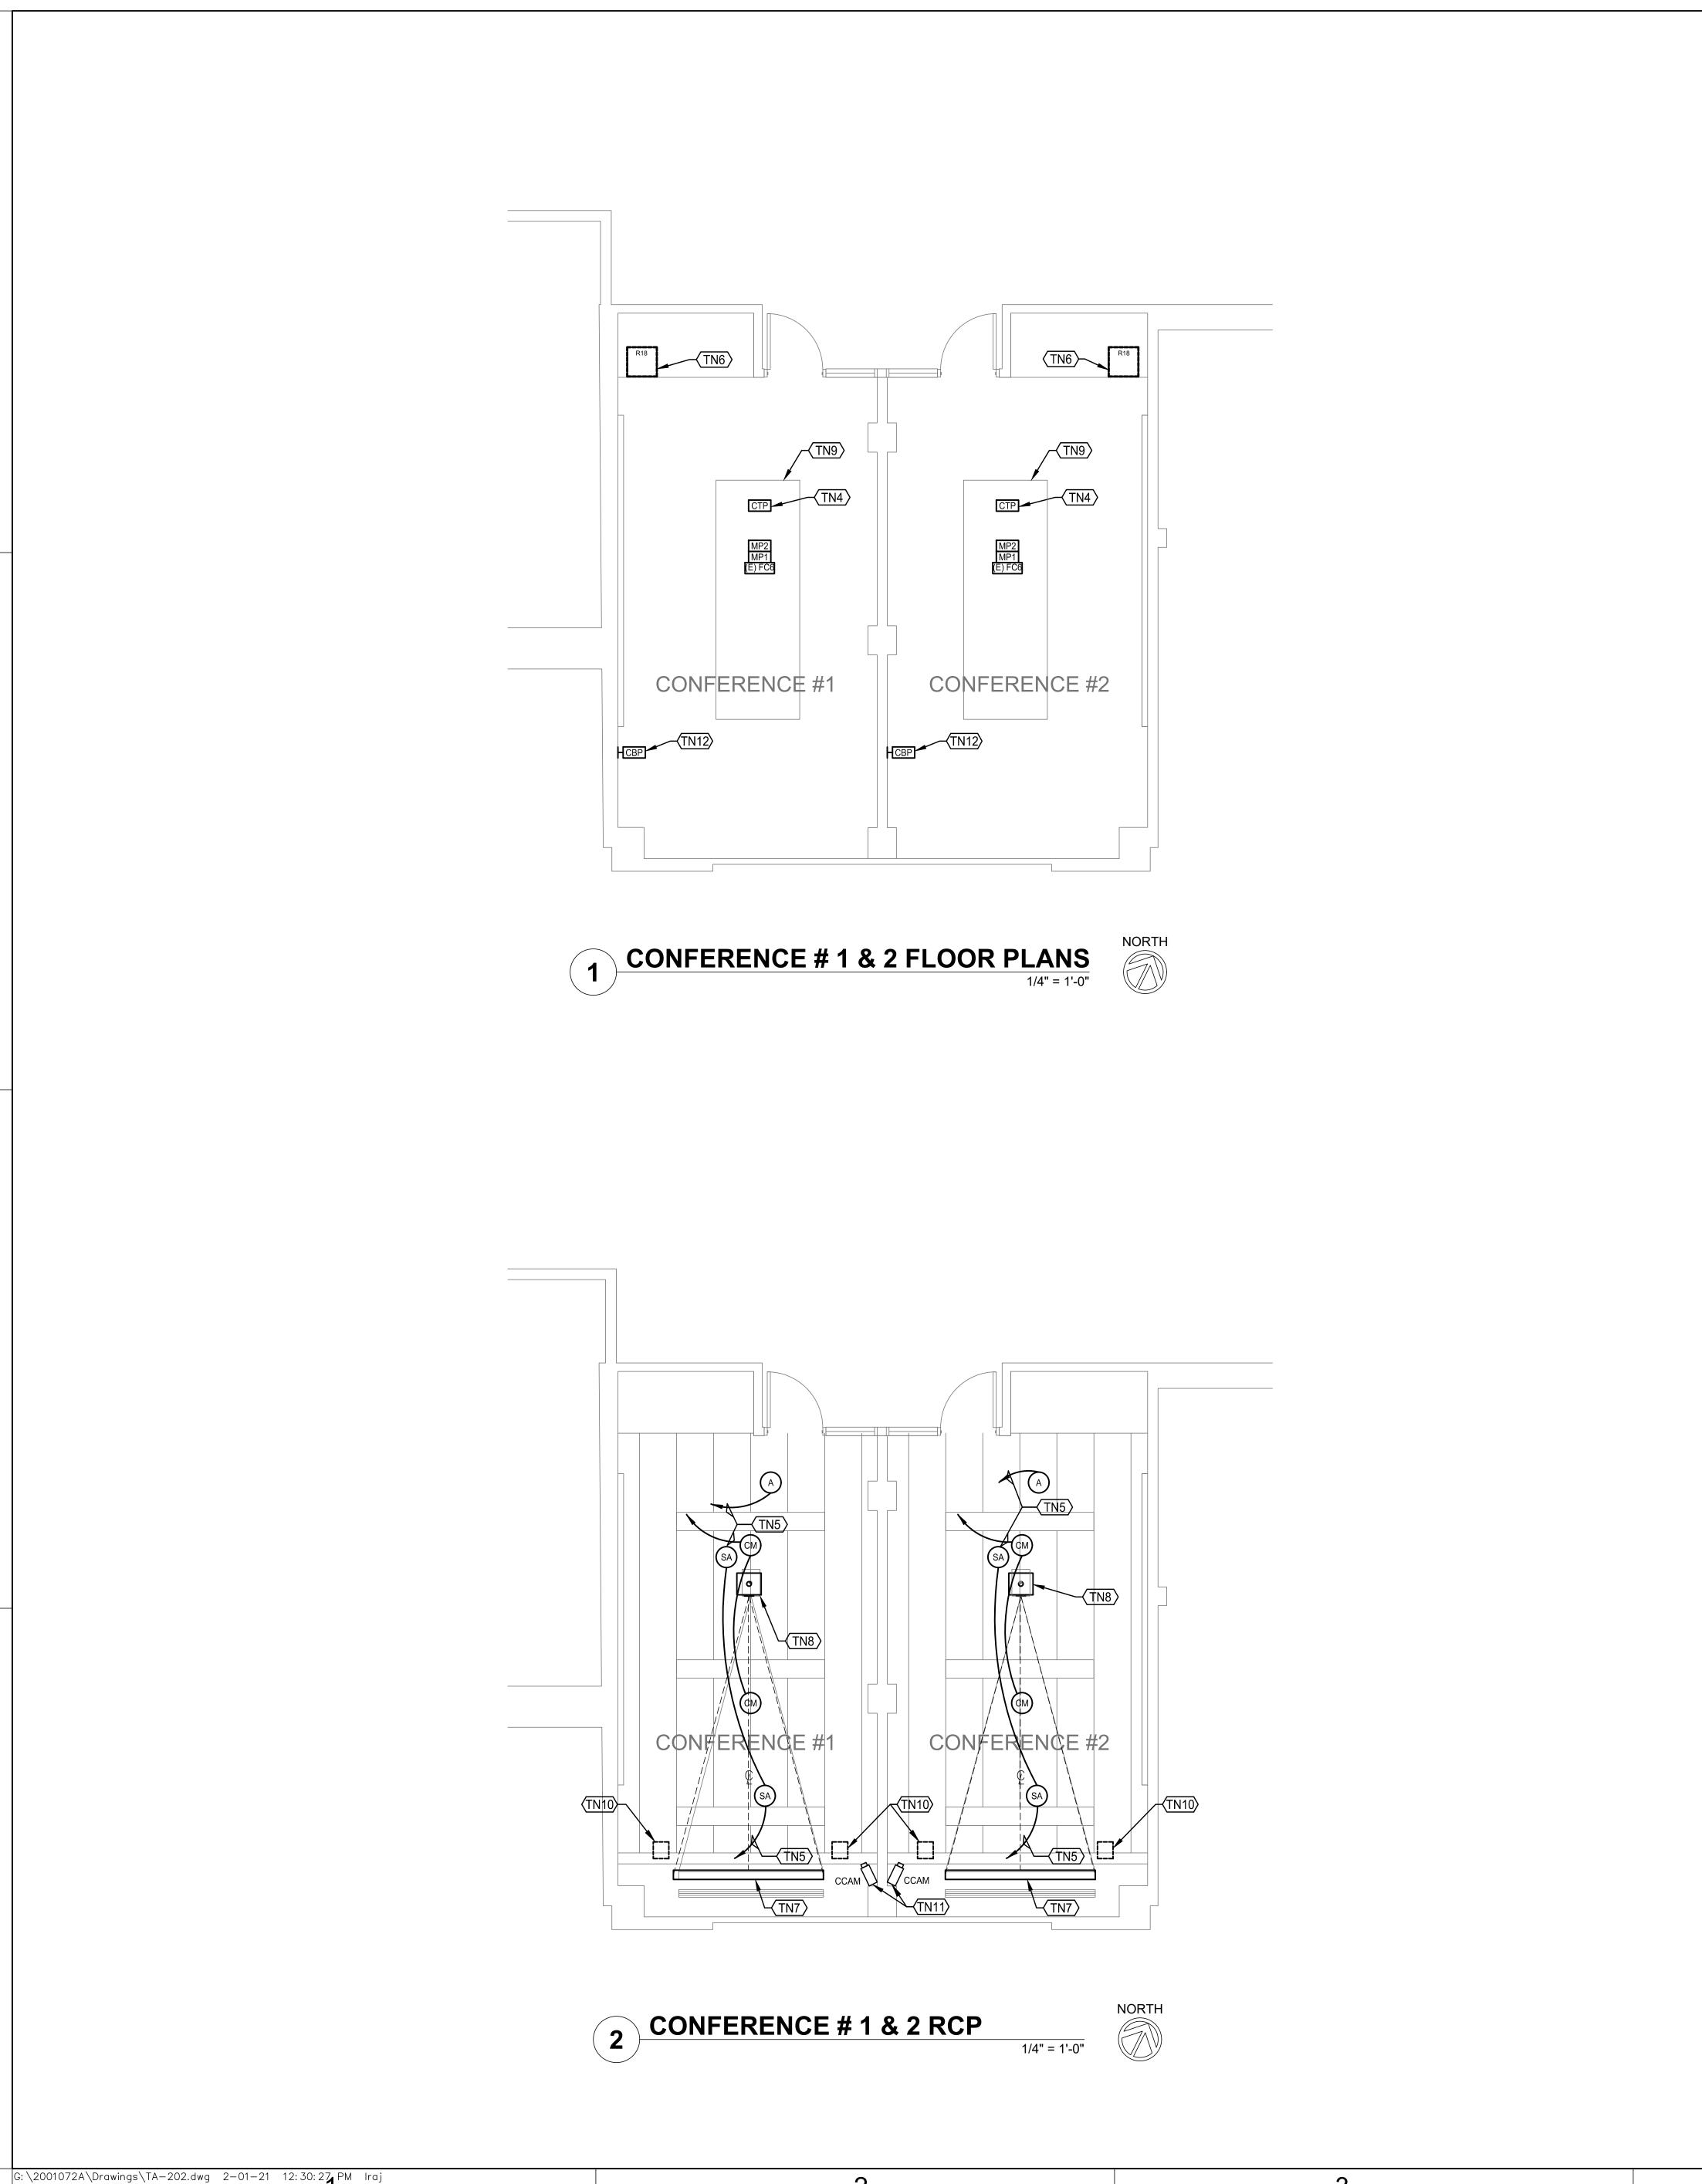
ABBREVIATIONS, LEGEND AND SYMBOL

**AS SHOWN** PROJECT NUMBER: 01-119293

SHEET NUMBER:


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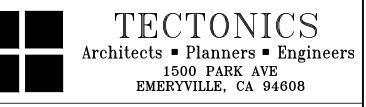


### **KEYNOTES**

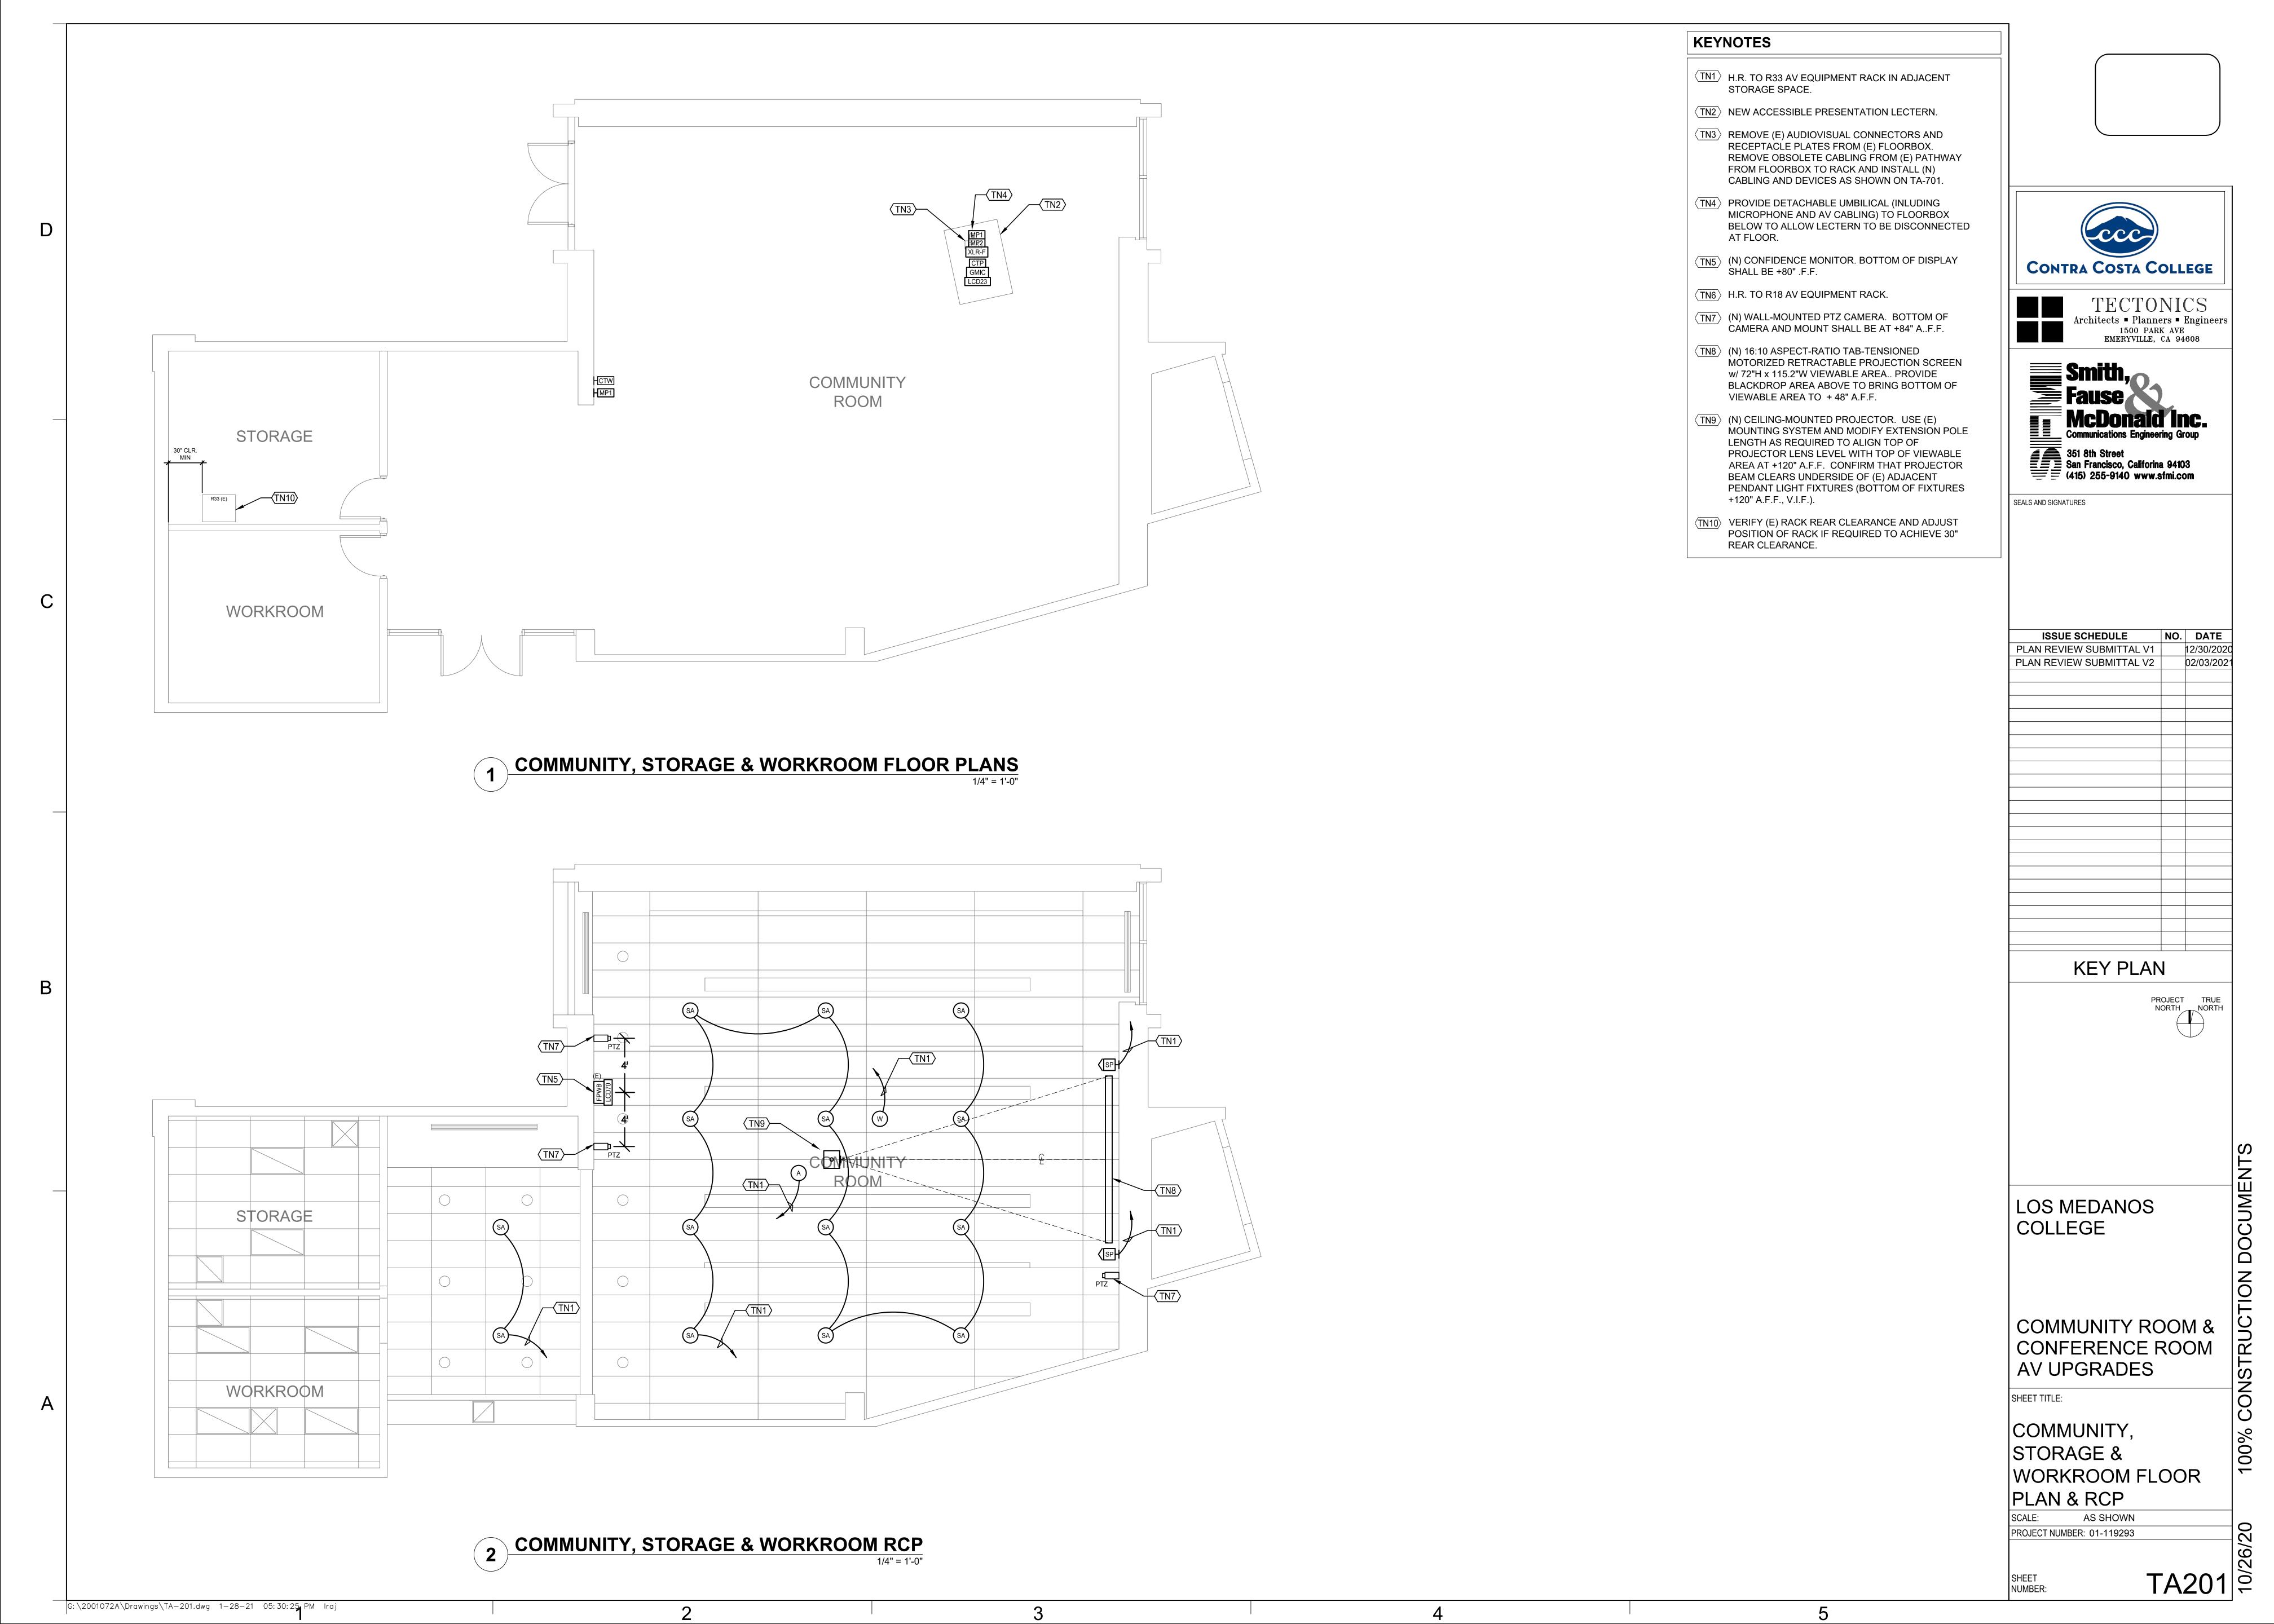- TN AUDIOVISUAL SYSTEMS: WORK OF DIVISION 27.
- $\langle TN1 \rangle$  NOT USED.
- ⟨TN2⟩ NOT USED.
- TN3 REMOVE (E) AUDIOVISUAL CONNECTORS AND RECEPTACLE PLATES FROM (E) FLOORBOX. INSTALL (N) MP1 RECEIVER. REMOVE OBSOLETE CABLING FROM (E) PATHWAY FROM FLOORBOX TO RACK AND INSTALL (N) CABLING AS SHOWN ON FUNCTIONAL DIAGRAM, SEE TA-701.
- TN4 (N) TOPSET AV CONTROL PANEL. PROVIDE DETACHABLE UMBILICAL TO CONNECTION IN FLOORBOX BELOW.
- TN5 H.R. TO R18 AV EQUIPMENT RACK.
- (N) CREDENZA-HEIGHT SWING-OUT AV EQUIPMENT RACK. COORDINATE MODIFICATION OF (E)
  CASEWORK W/ OWNER'S REPRESENTATIVE TO PROVIDE CLEARANCE FOR RACK AND SLIDE-OUT/PIVOT MECHANISM.
- (N) 16:10 ASPECT-RATIO TAB-TENSIONED
  MOTORIZED RETRACTABLE PROJECTION SCREEN
  w/ 60"H x 96"W VIEWABLE AREA. REUSE (E)
  HOUSING/ MOUNTS. PROVIDE BLACKDROP AREA
  ABOVE TO BRING BOTTOM OF VIEWABLE AREA TO +
  48" A.F.F.
- TN8 (N) CEILING-MOUNTED PROJECTOR. USE (E)
  MOUNTING SYSTEM AND MODIFY EXTENSION POLE
  LENGTH AS REQUIRED TO ALIGN TOP OF
  PROJECTOR LENS LEVEL WITH TOP OF VIEWABLE
  AREA AT +108" A.F.F. CONFIRM THAT PROJECTOR
  BEAM CLEARS UNDERSIDE OF (E) ADJACENT
  PENDANT LIGHT FIXTURES (BOTTOM OF FIXTURES
  +108" A.F.F., V.I.F.).
- TN9 EXISTING CONFERENCE ROOM TABLE TO REMAIN.
- TN10 REMOVE (E) SURFACE MOUNT LOUDSPEAKERS, PATCH AND PAINT AS REQ'D.
- ⟨TN11⟩ (N) CONFERENCING CAMERA.
- (N) CONTROL BUTTON PANEL. INSTALL (N) CONTROL BUTTON PANEL AT (E) LOCATION +40" A.F.F. TO CL.





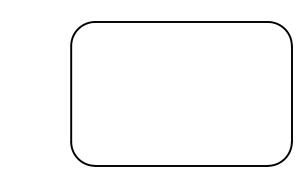



SEALS AND SIGNATURES

ISSUE SCHEDULE	NO.	DATE
PLAN REVIEW SUBMITTAL V1		12/30/202
PLAN REVIEW SUBMITTAL V2		02/03/202
	1	

### **KEY PLAN**

PROJECT TRUE NORTH NORTH

LOS MEDANOS COLLEGE

COMMUNITY ROOM & CONFERENCE ROOM AV UPGRADES

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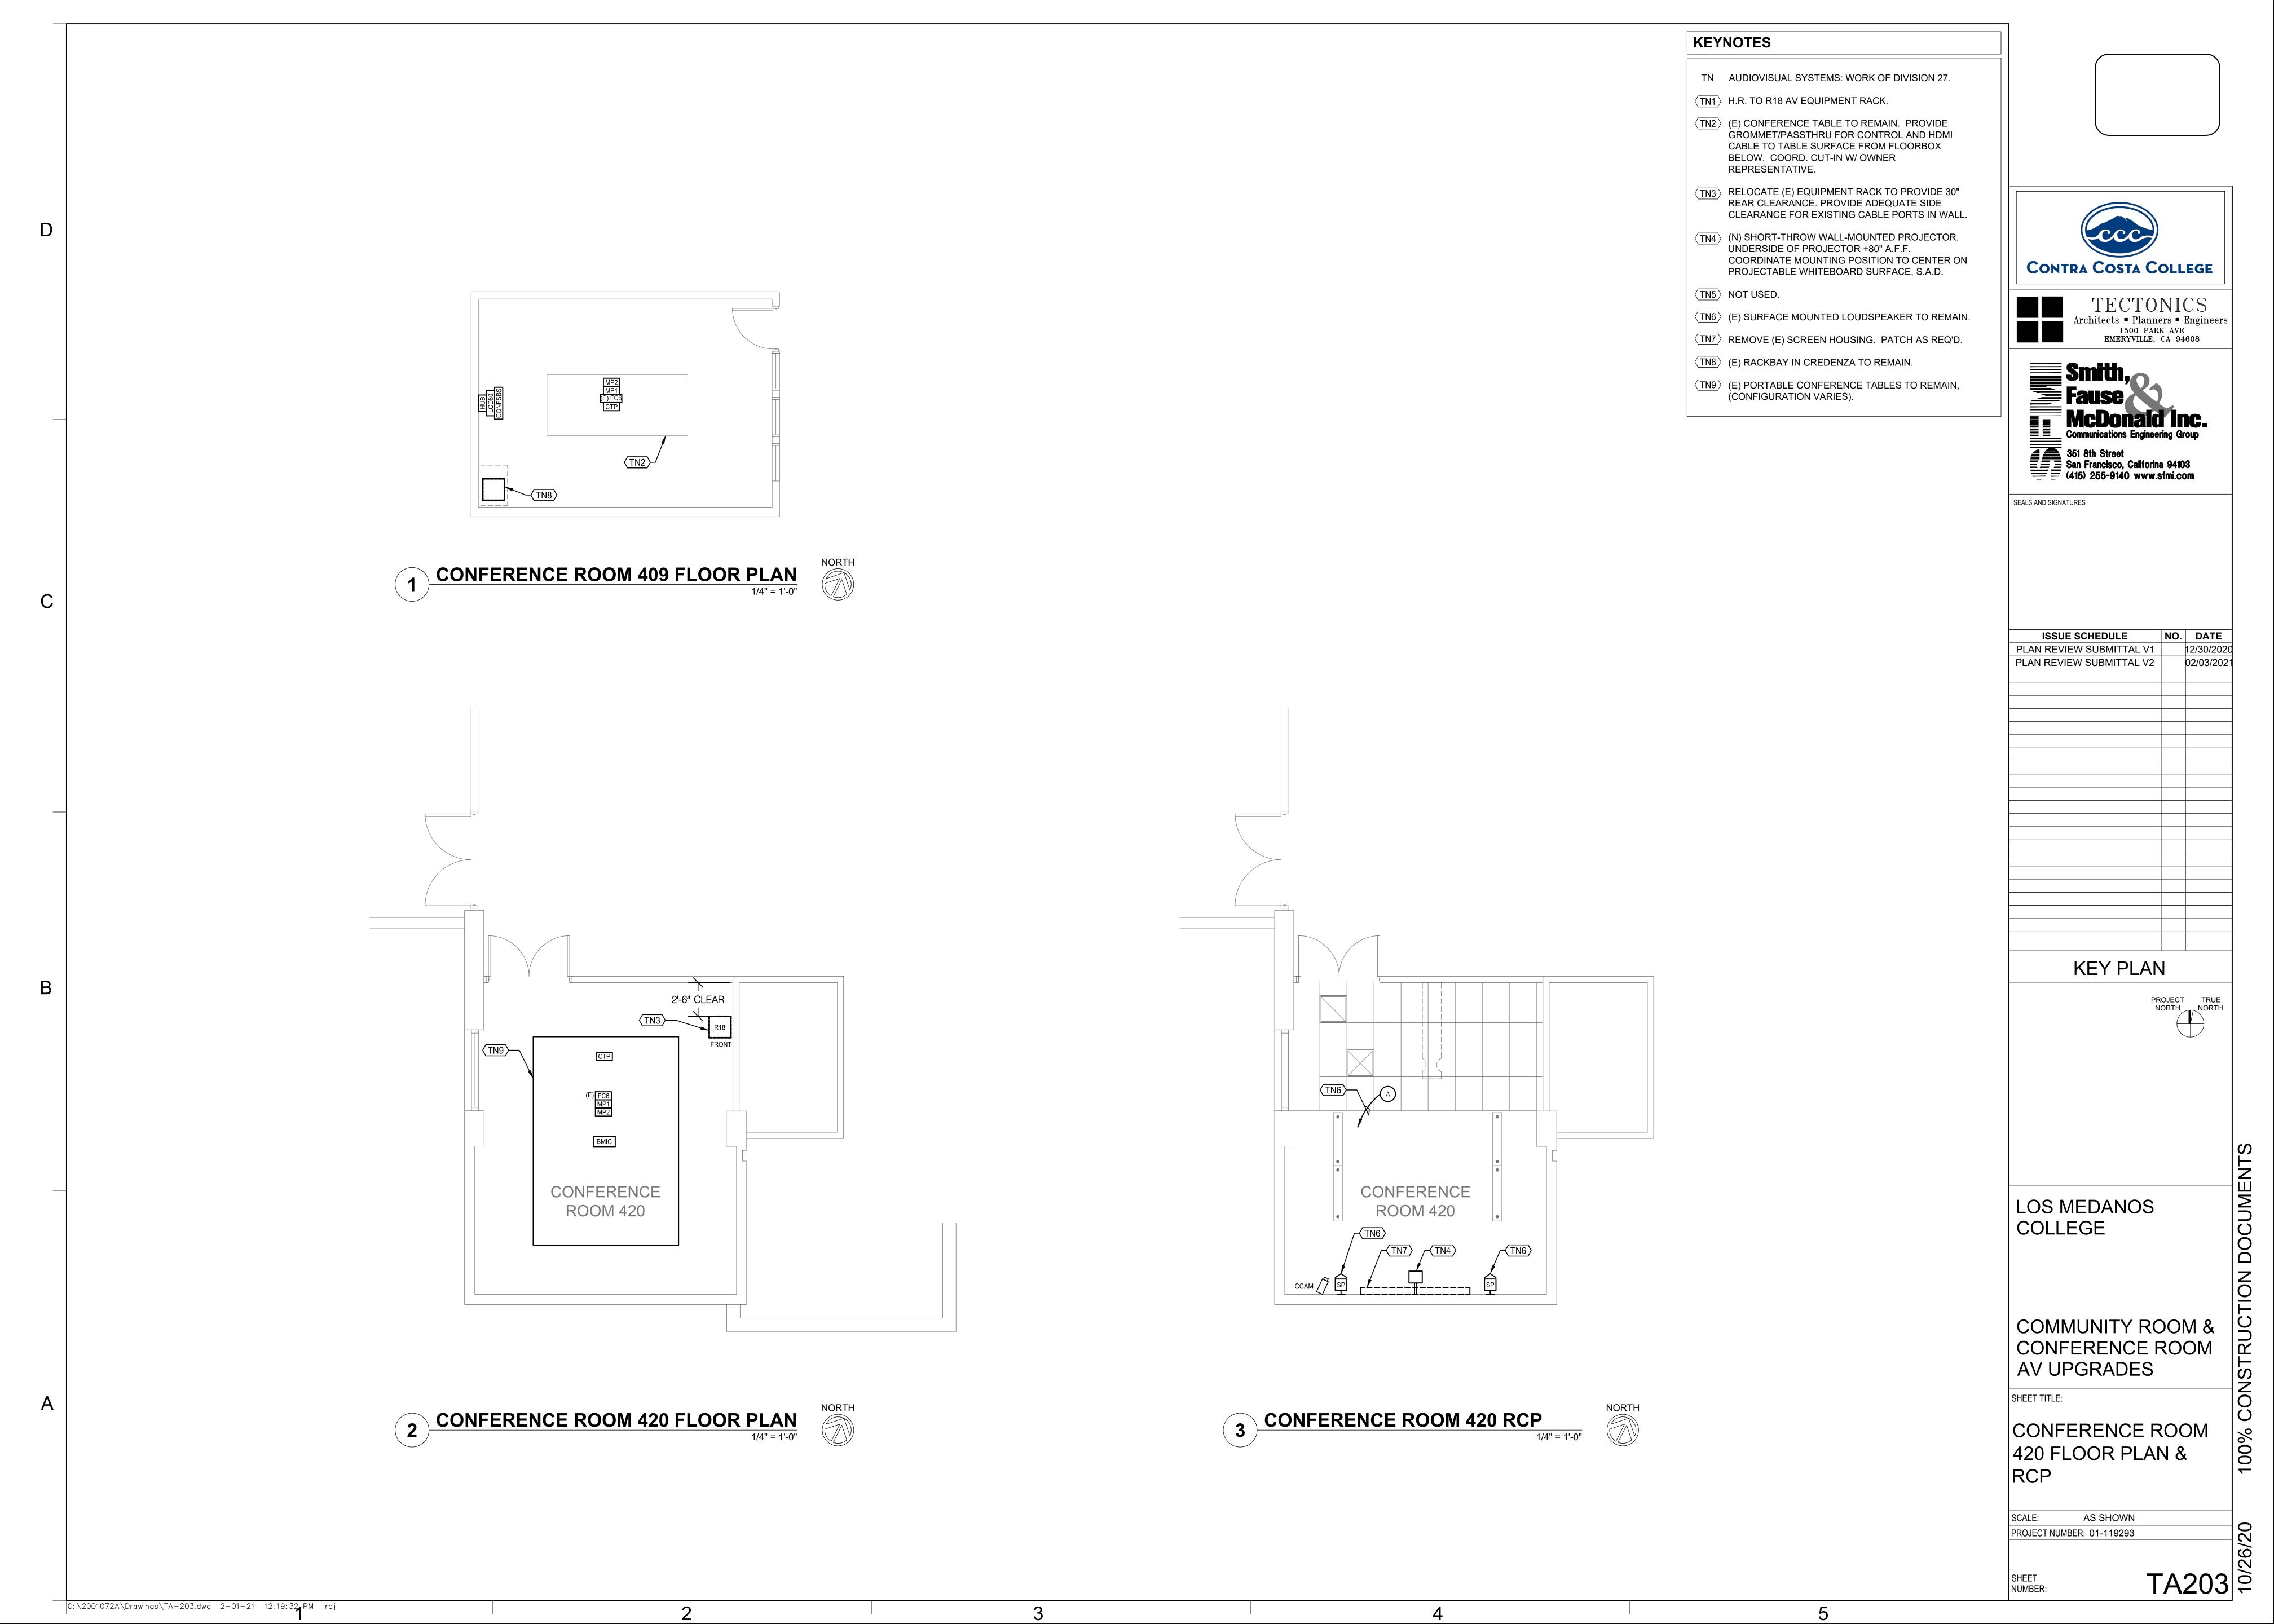
CONFERENCE # 1 & 2 FLOOR PLAN & RCP


SCALE: AS SHOWN
PROJECT NUMBER: 01-119293


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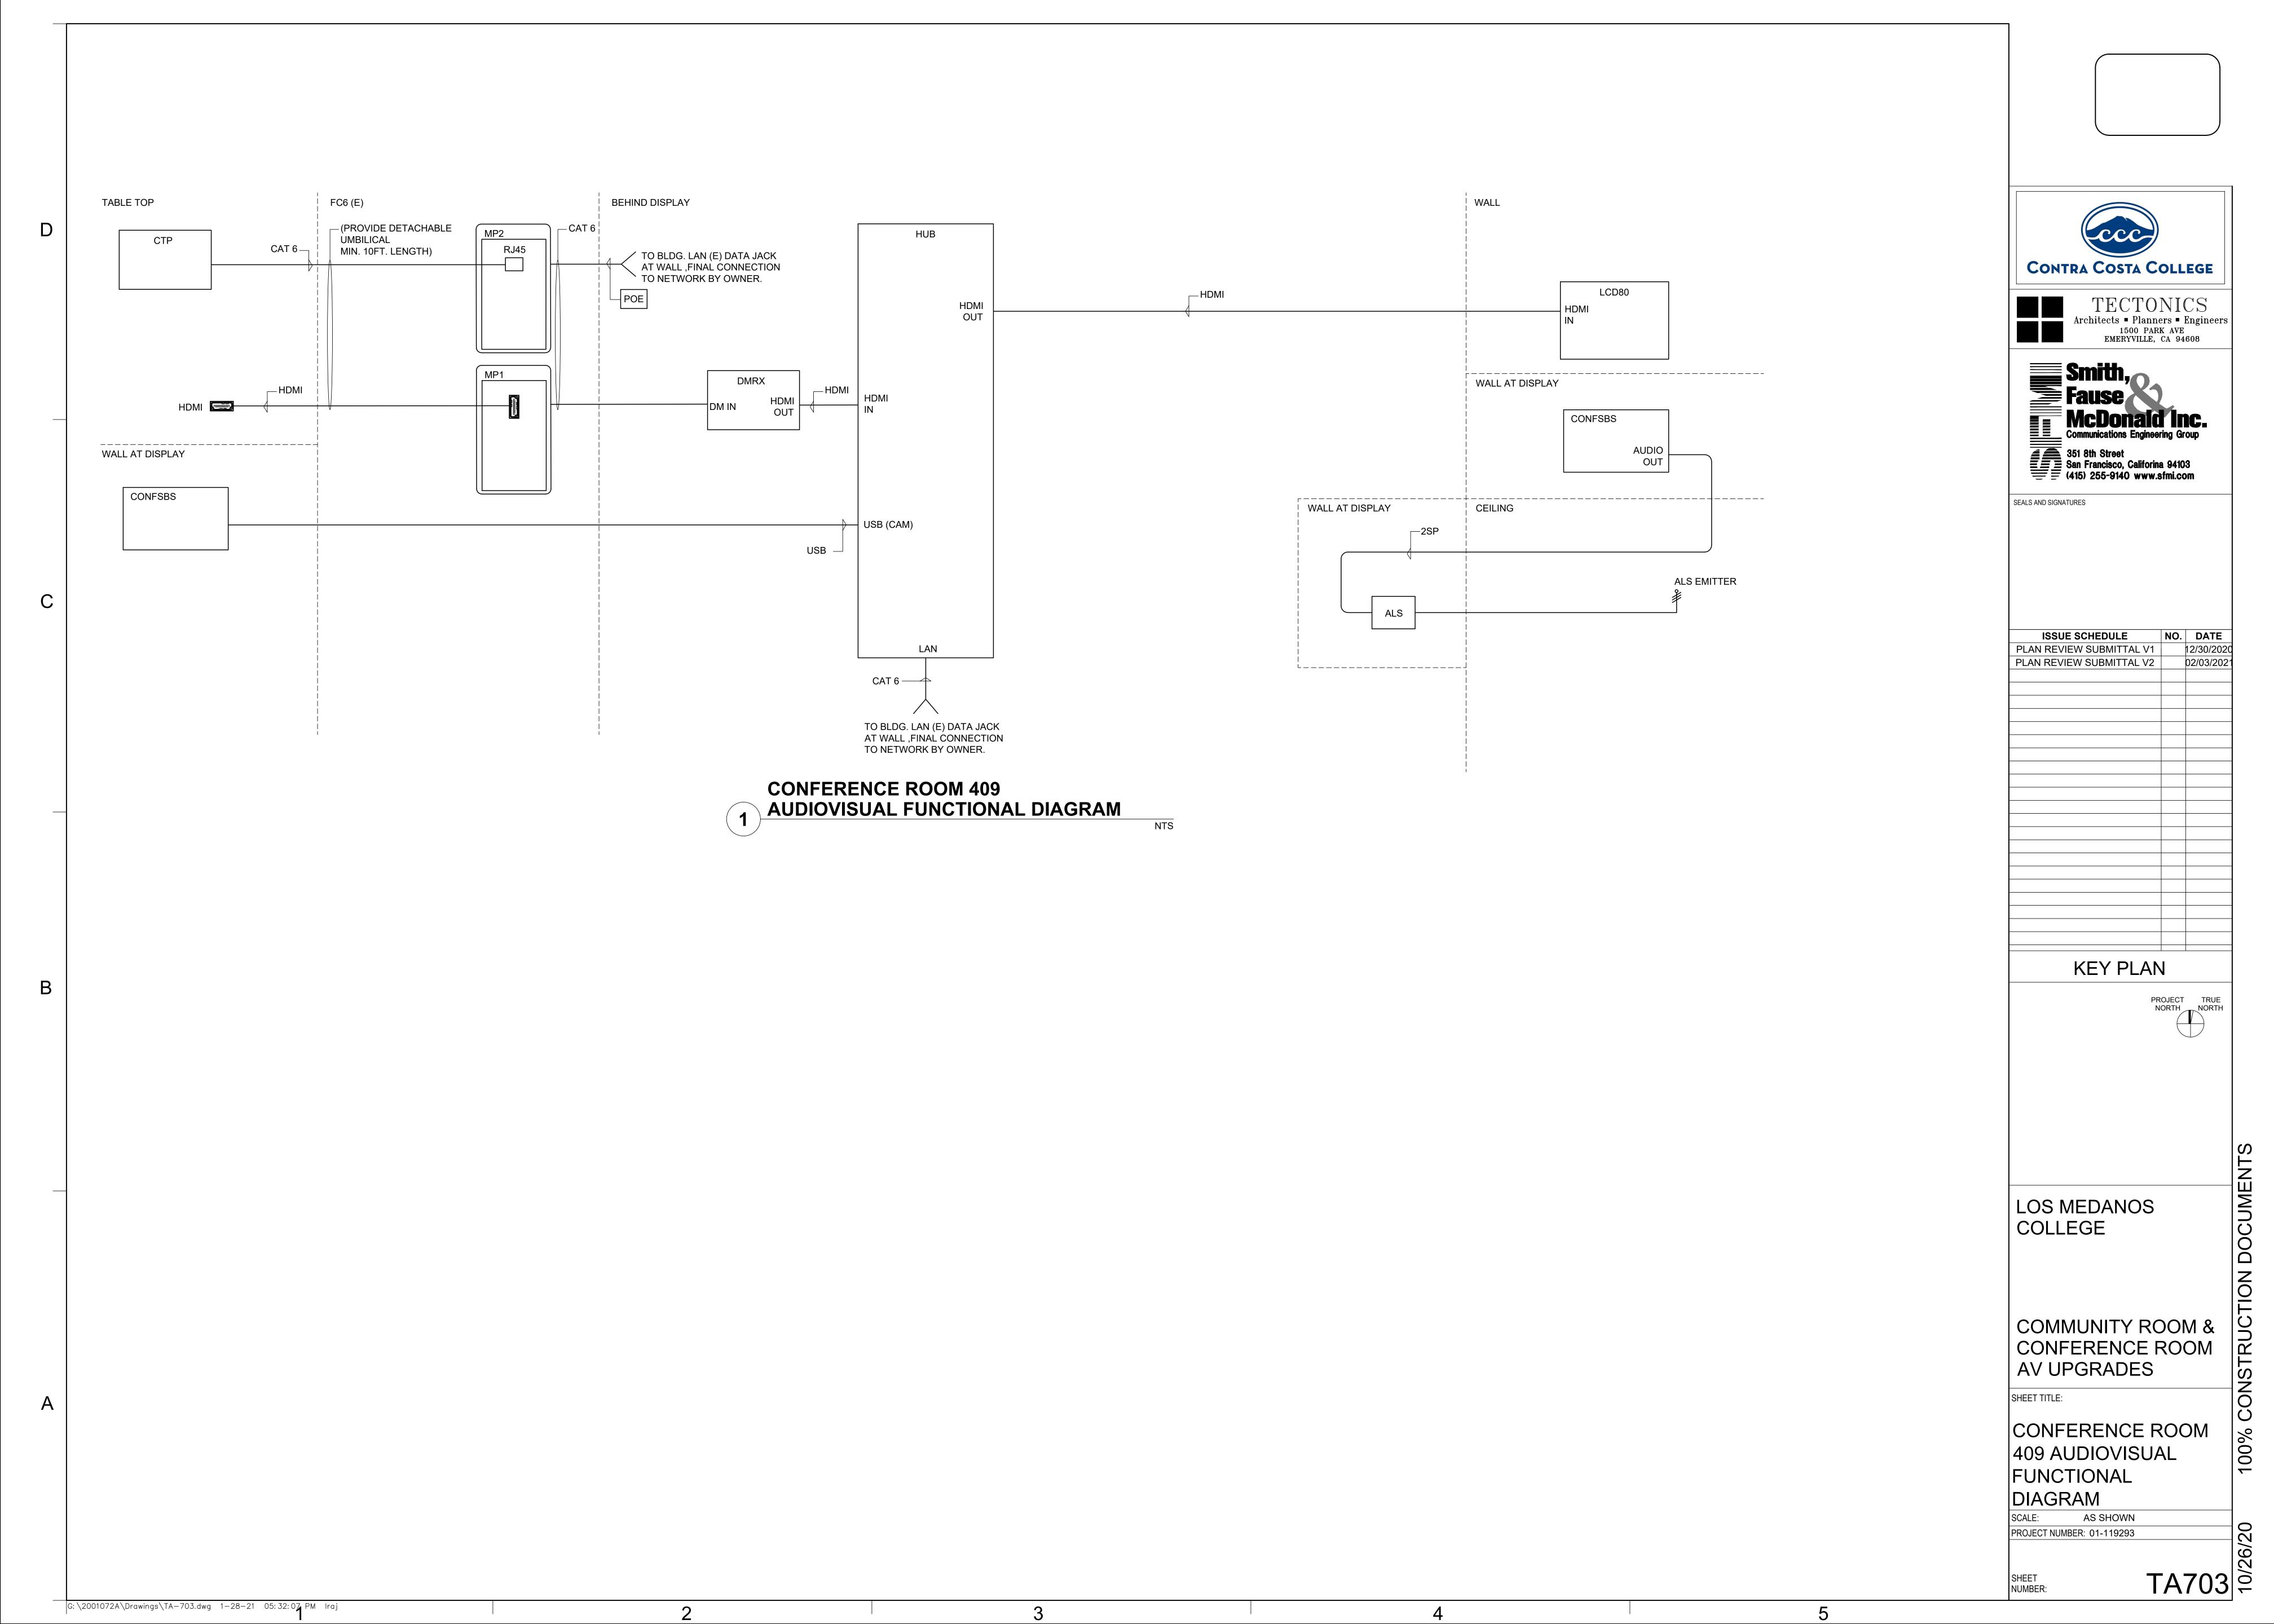
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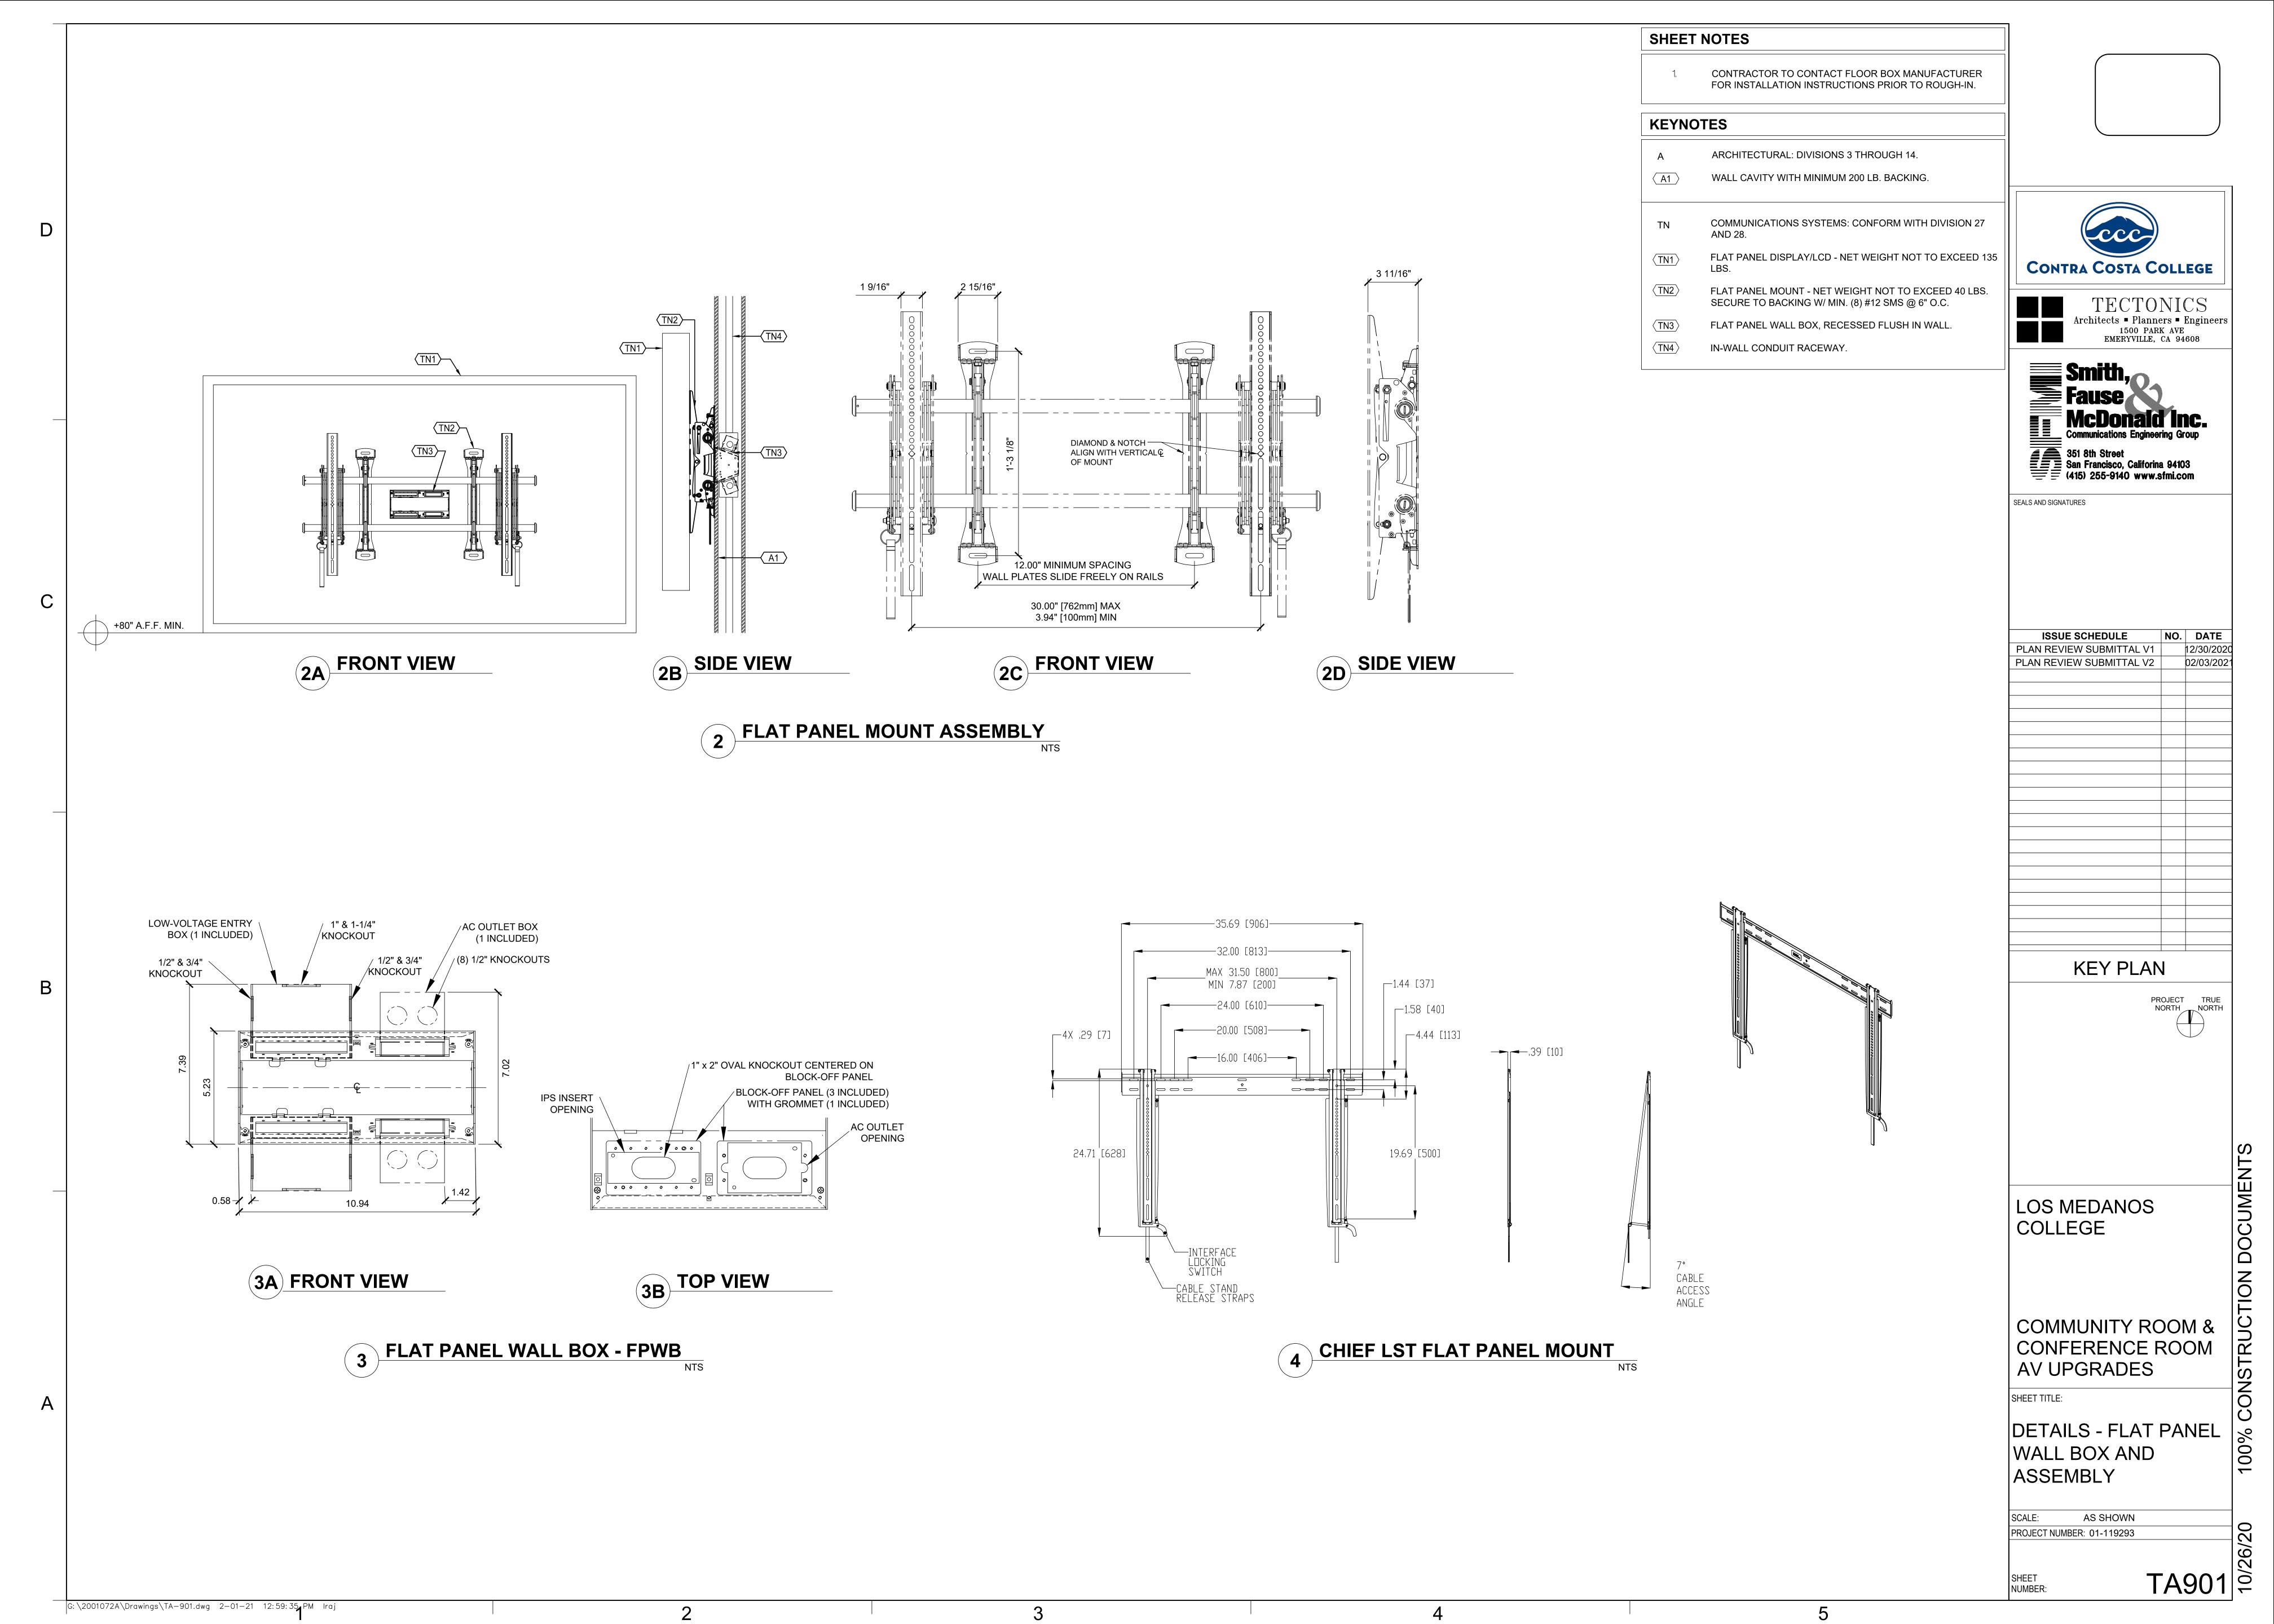
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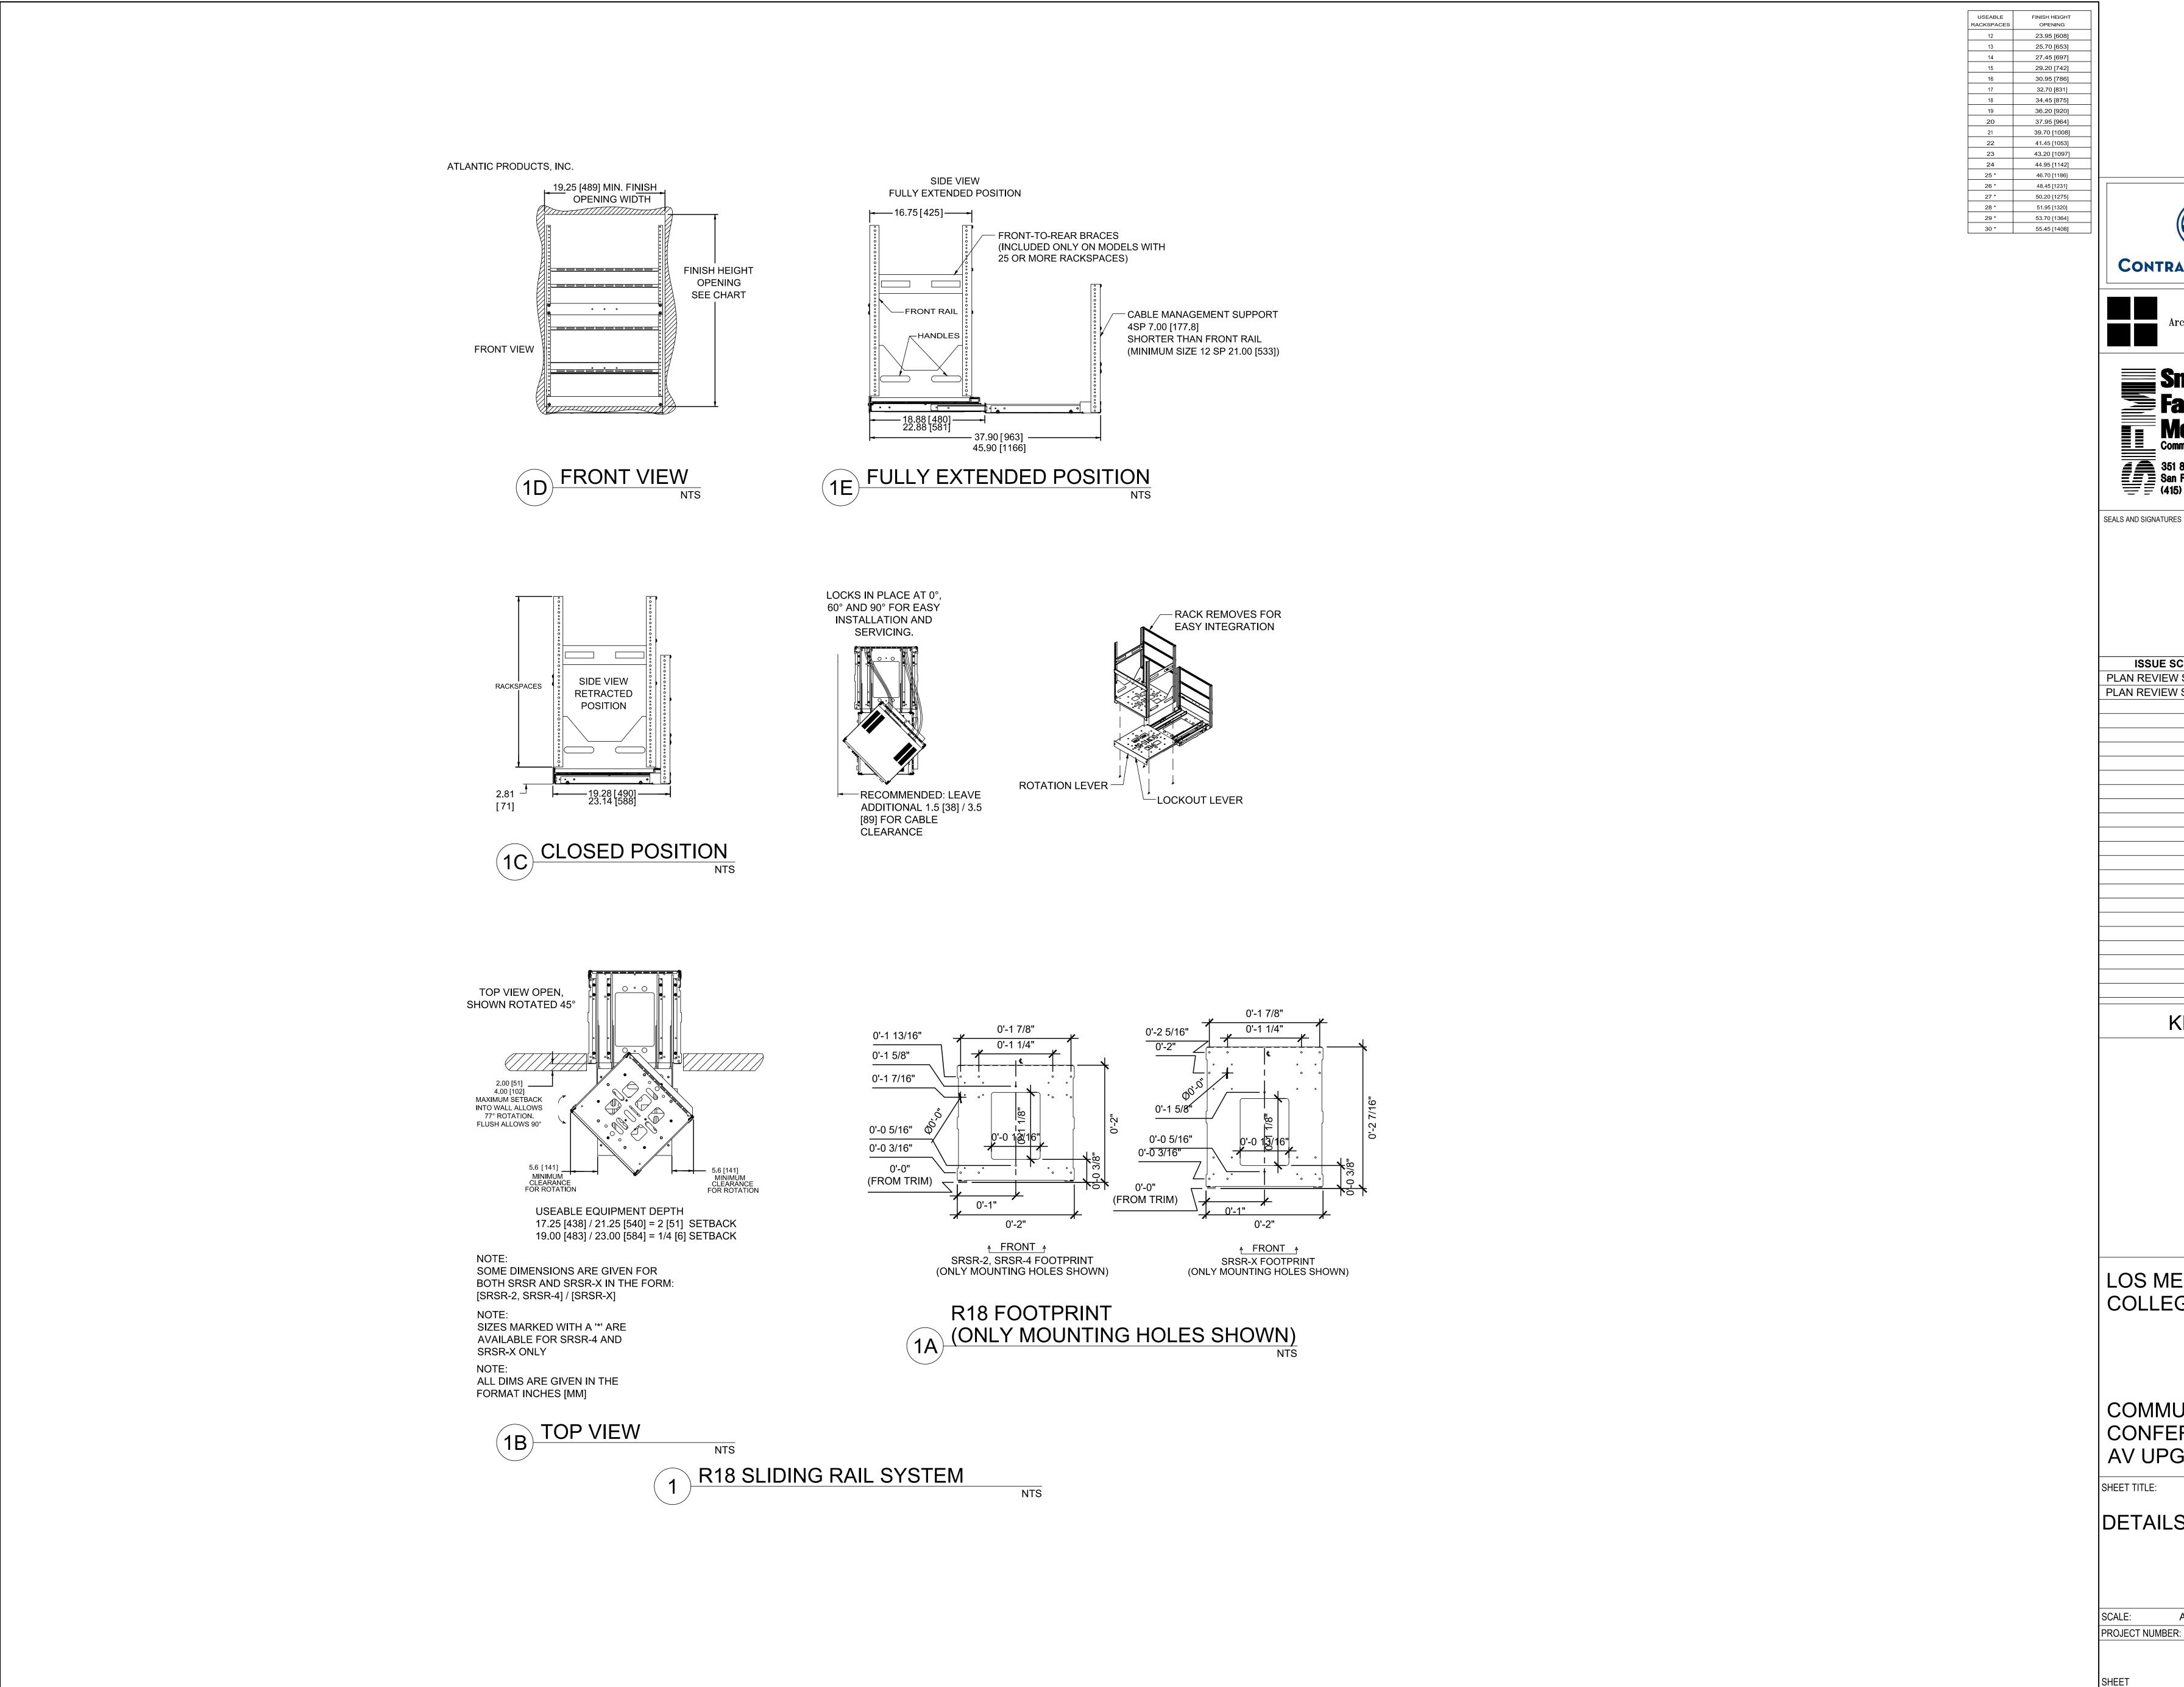









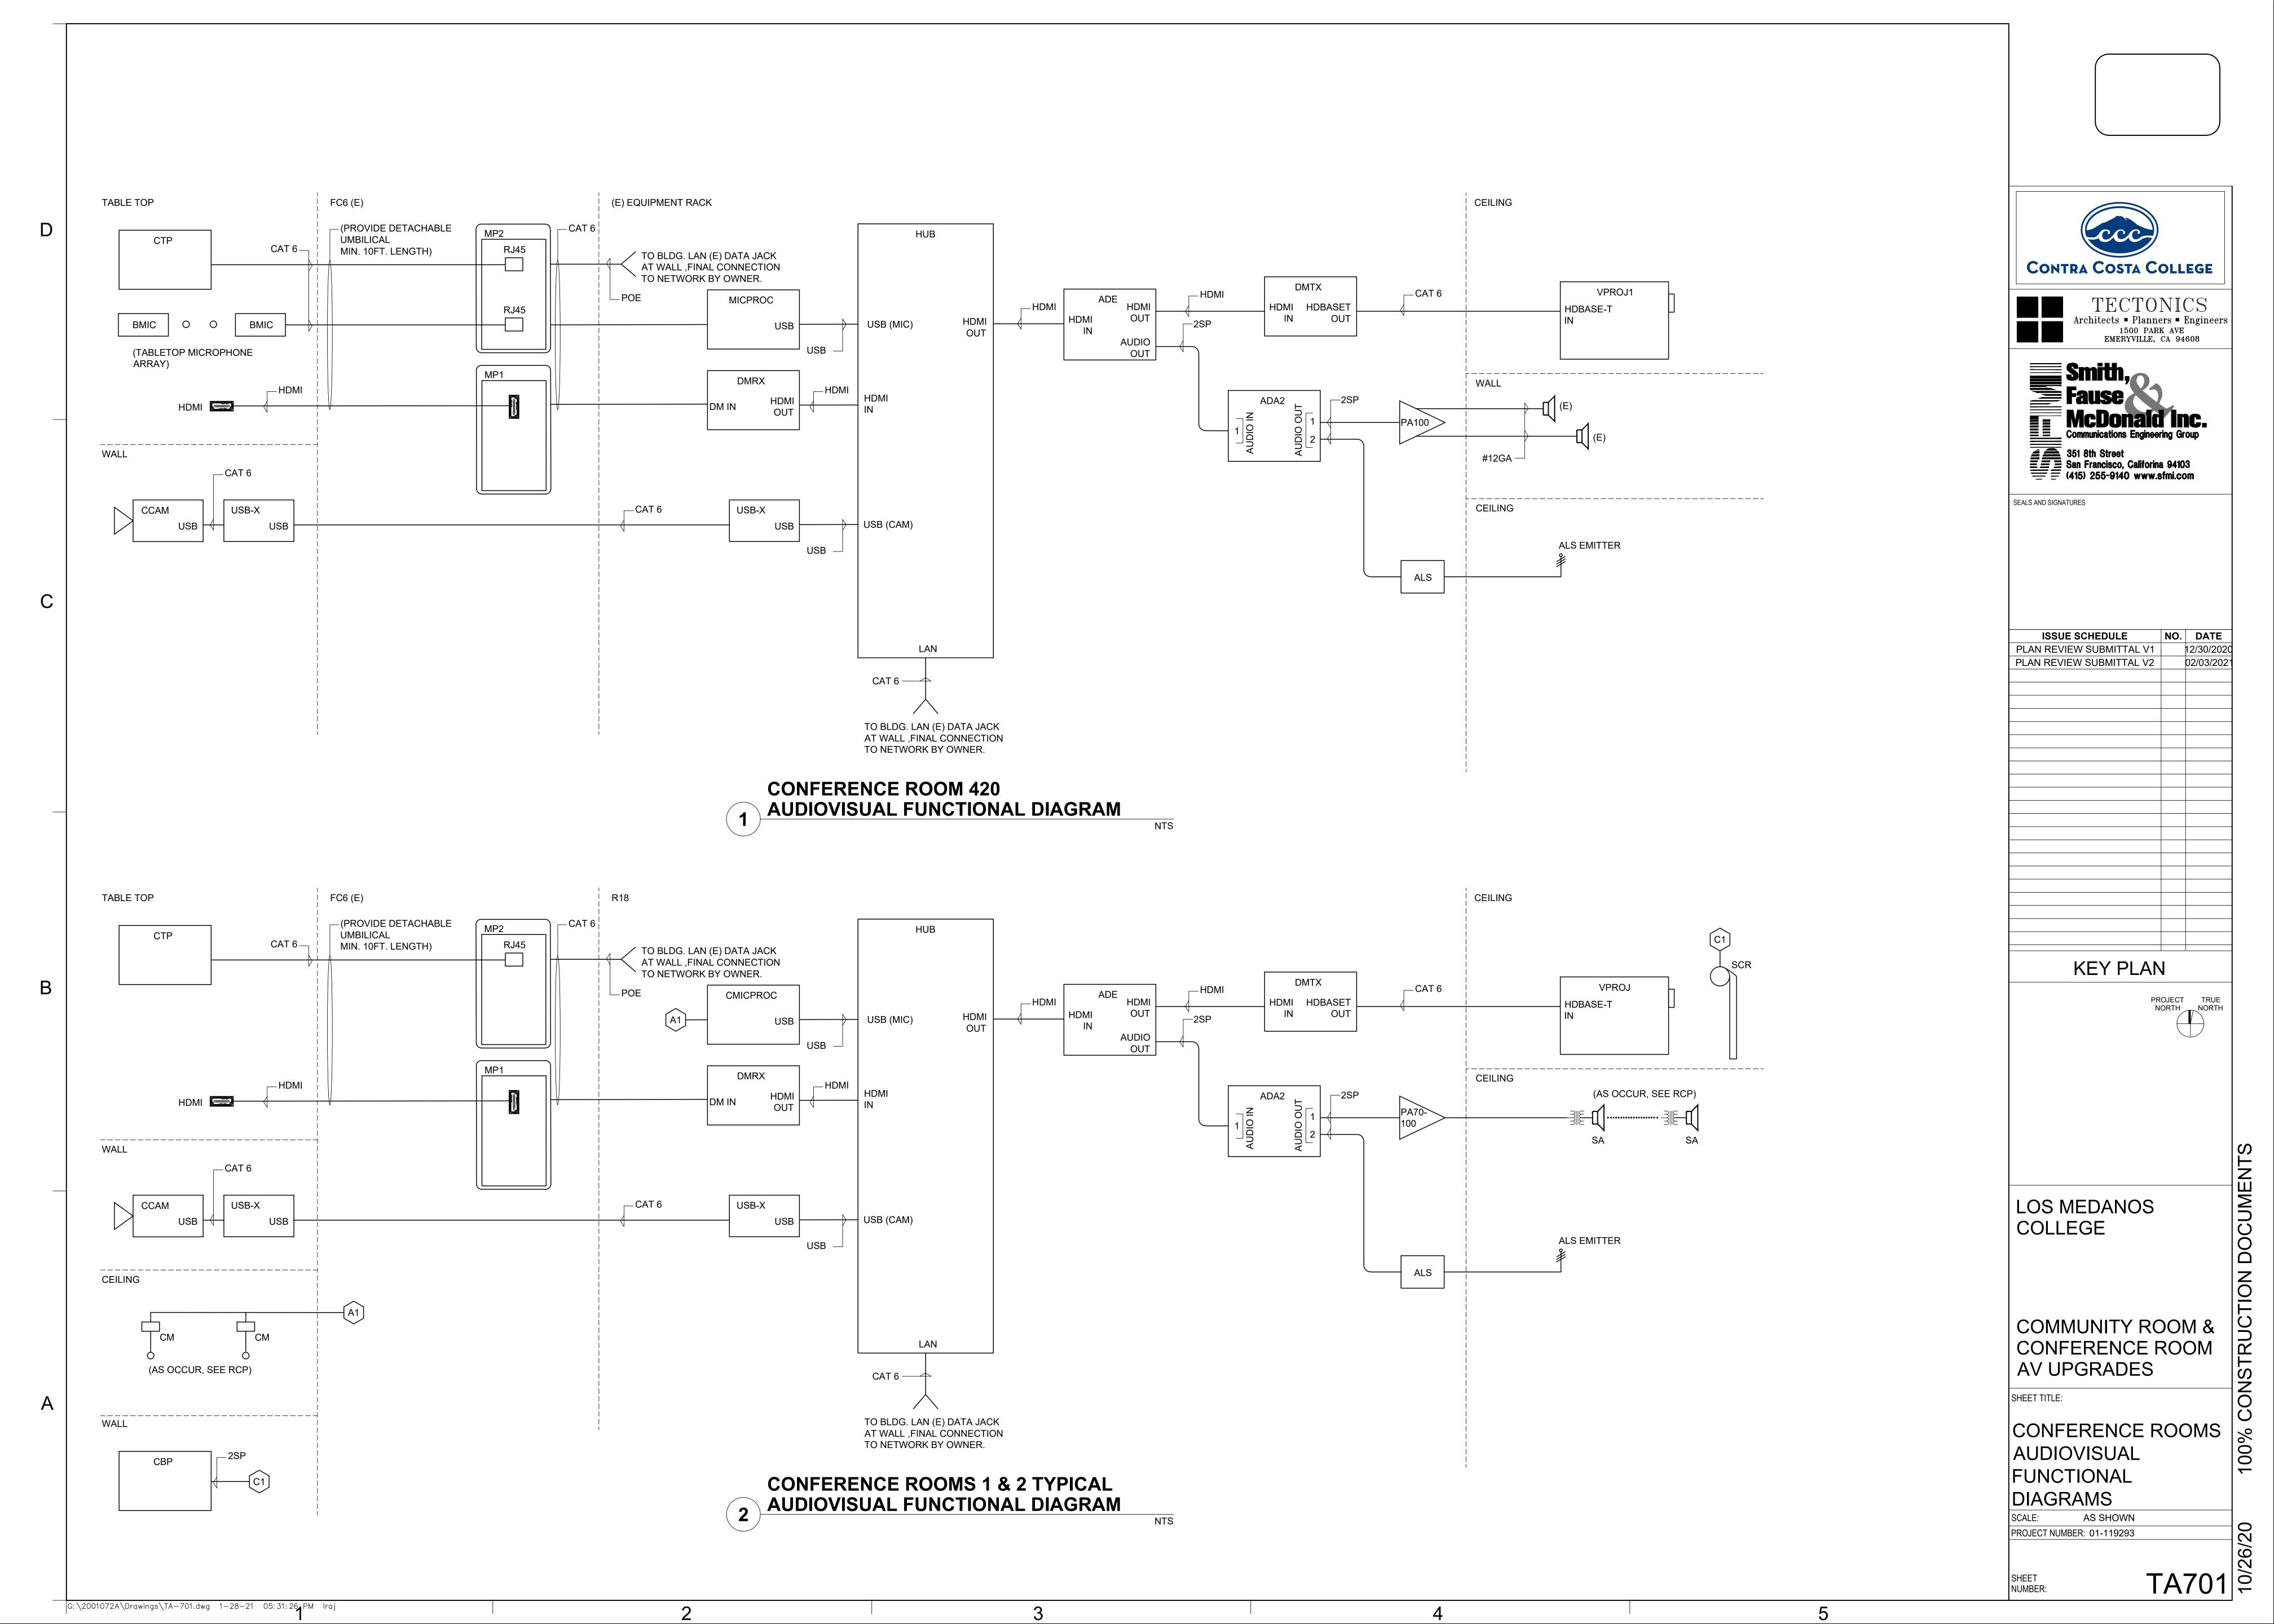

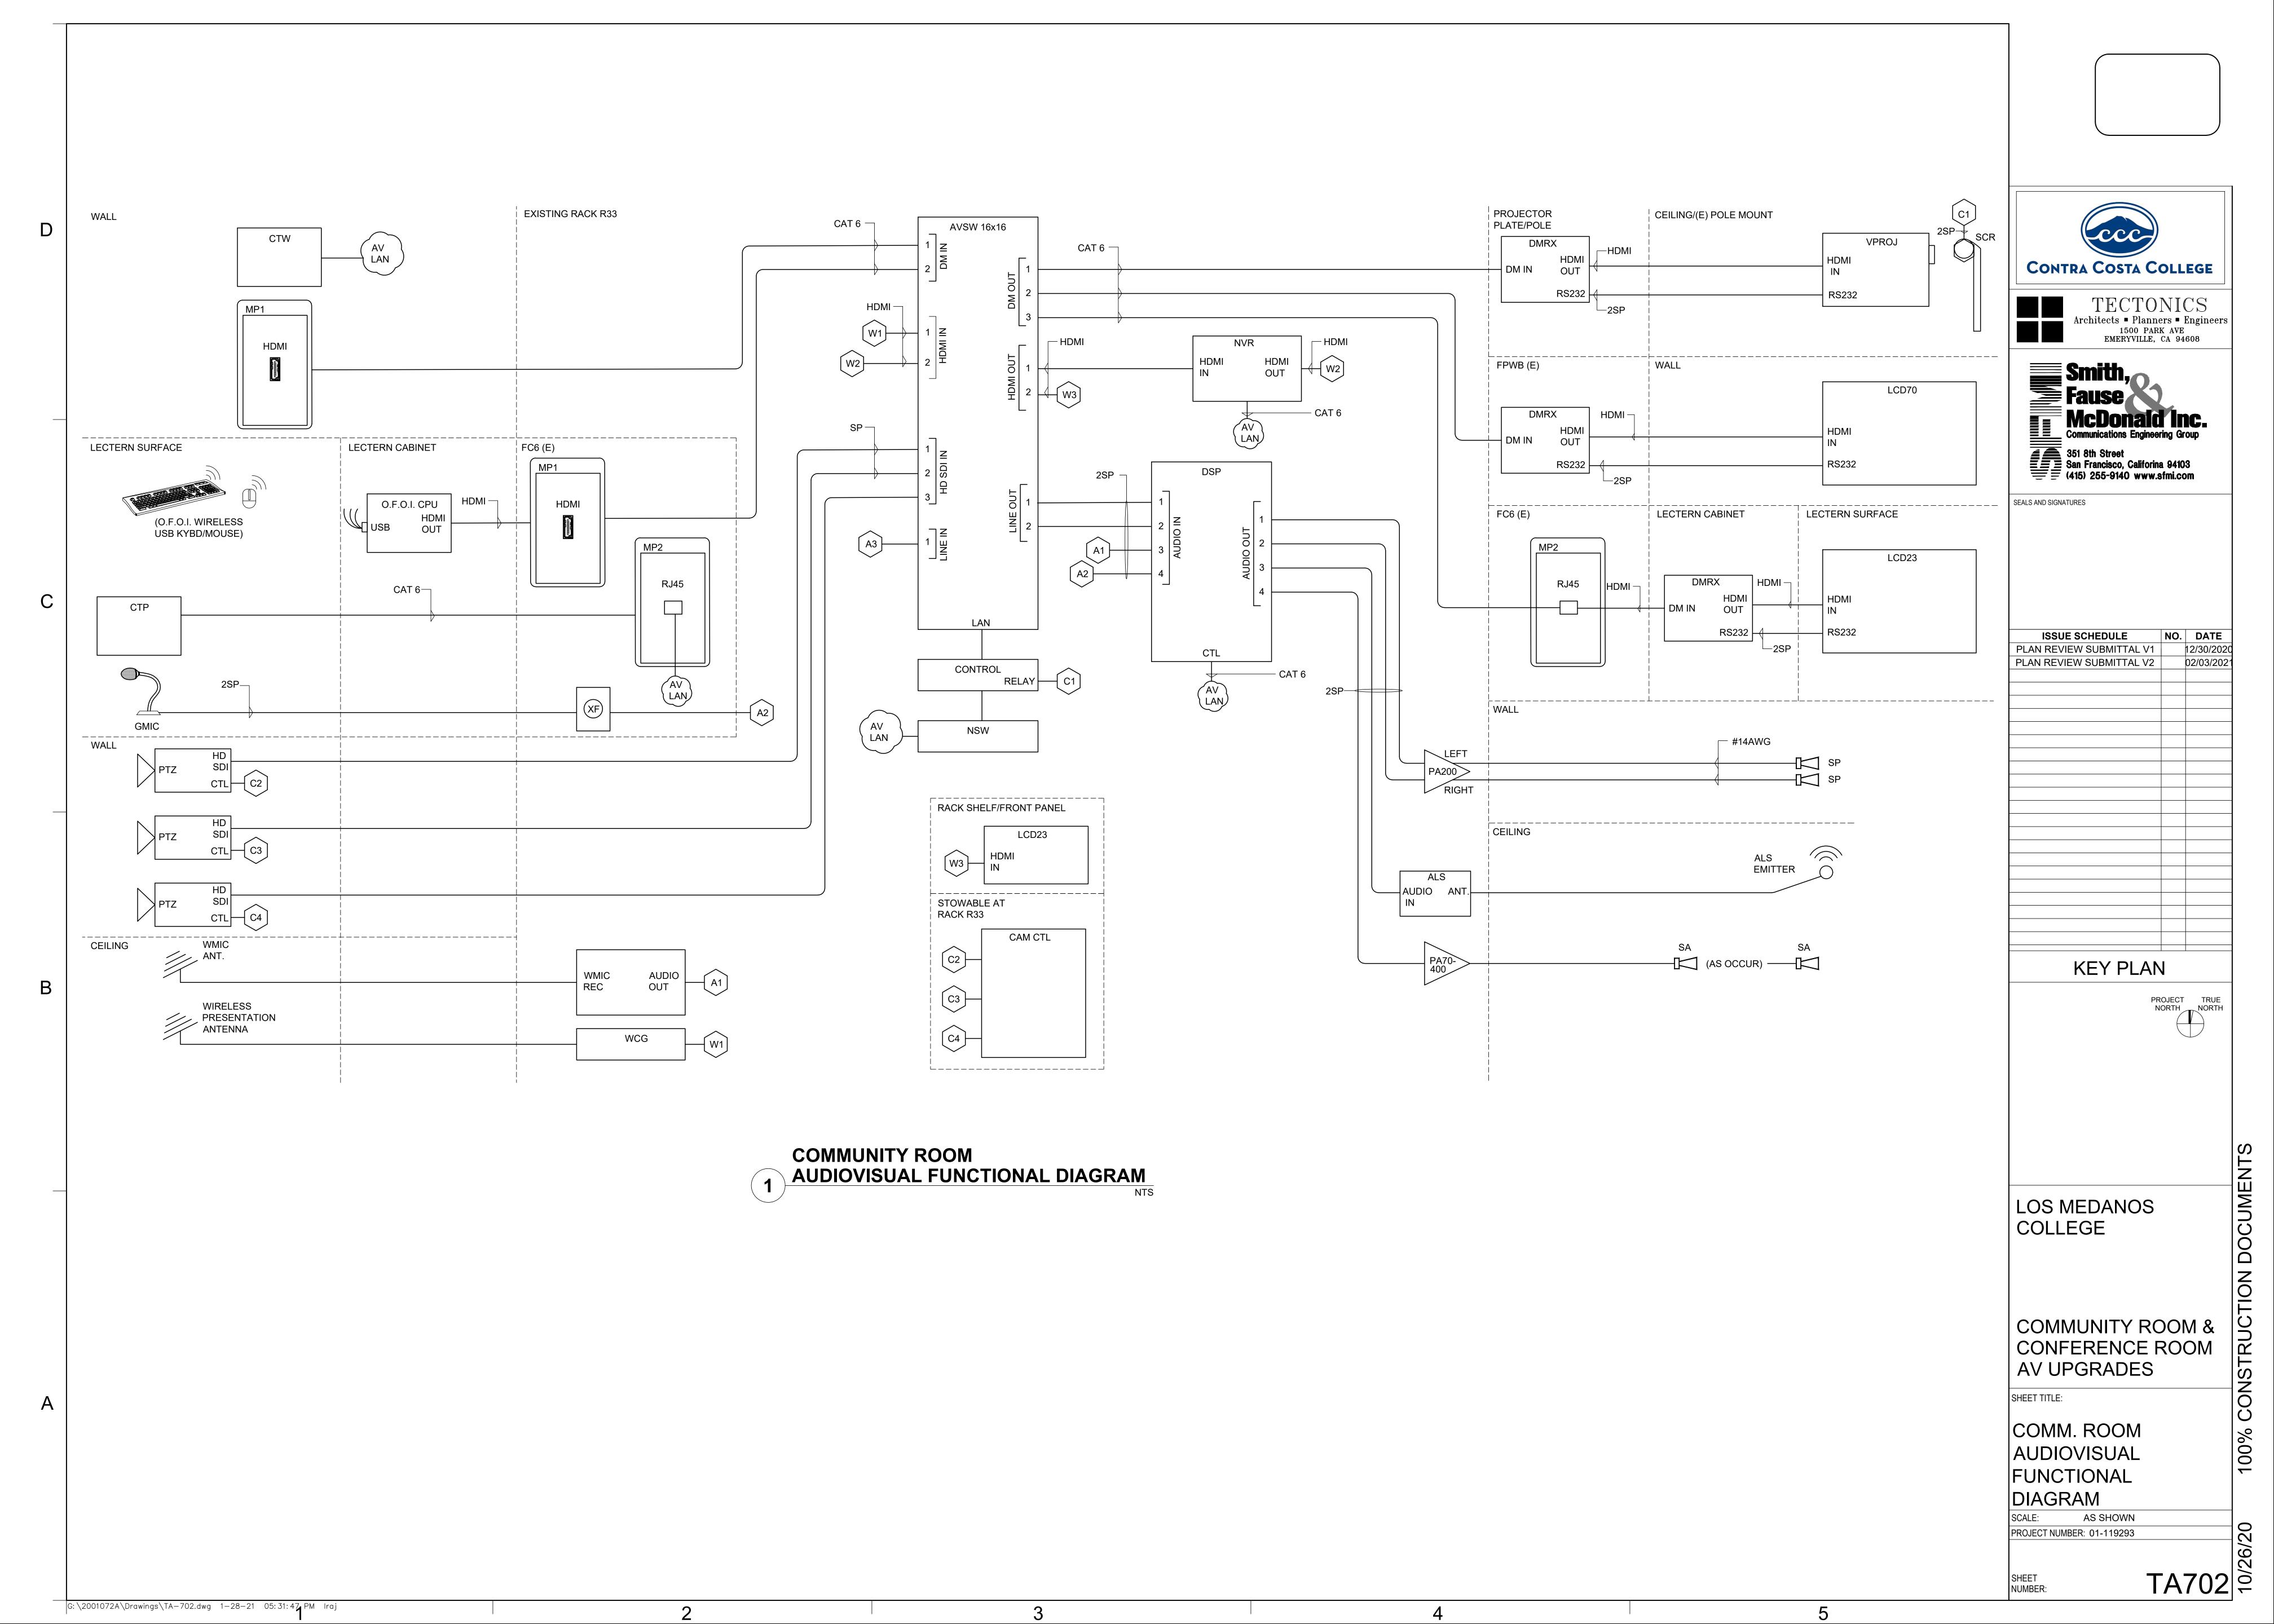

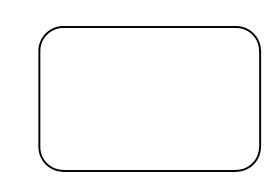








ISSUE SCHEDULE	NO.	DATE
PLAN REVIEW SUBMITTAL V1		12/30/20
PLAN REVIEW SUBMITTAL V2		02/03/20

## **KEY PLAN**

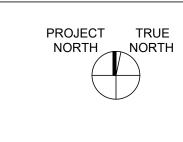

TION DOCUMENTS


LOS MEDANOS COLLEGE

COMMUNITY ROOM & CONFERENCE ROOM **AV UPGRADES** 

DETAILS - RACK R18

AS SHOWN PROJECT NUMBER: 01-119293

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**KEYNOTES** TN COMMUNICATIONS SYSTEMS: COMPLY WITH DIV. 27 & 28 COMMUNICATIONS GENERAL PROVISIONS AND COMMUNICATIONS SECTIONS REFERENCED THEREIN.

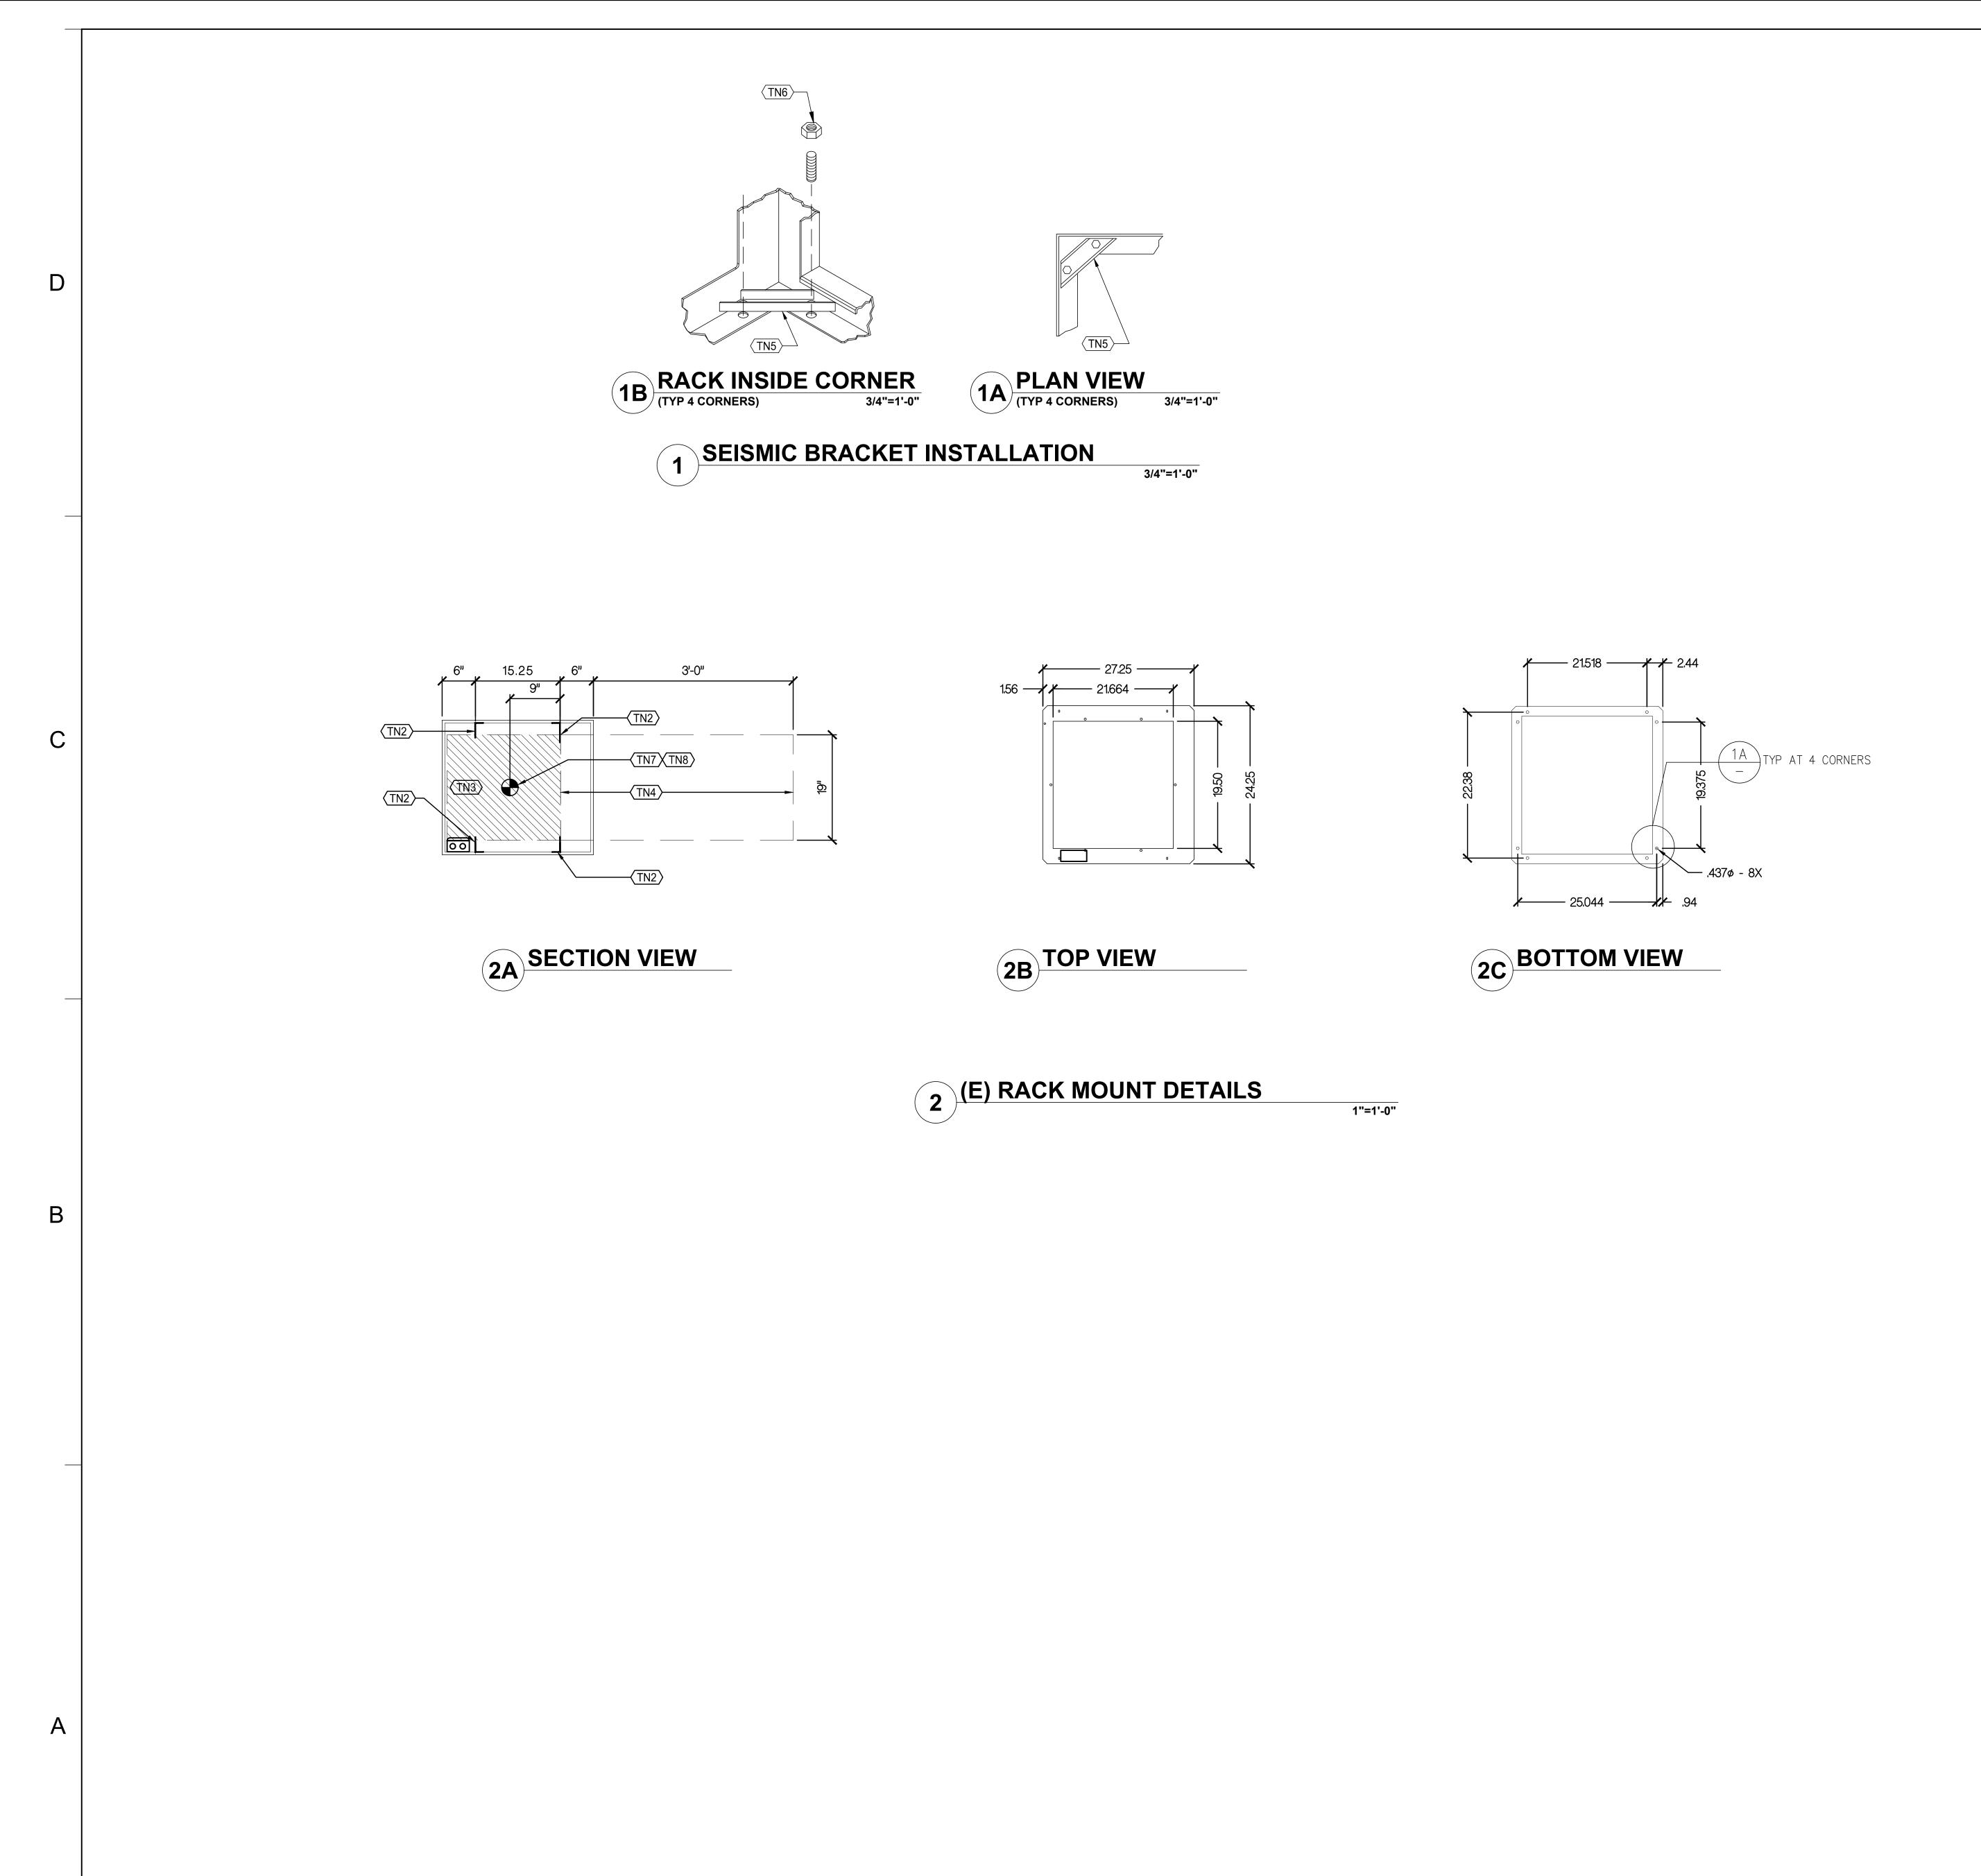(E) ENCLOSURE (RACK) FRAME. FASTEN TO FLOOR. SUBMIT

TN3 EQUIPMENT CLEAR MOUNTING AREA. HOLD VOLUME SHOWN CLEAR

EQUIPMENT CLEAR FRONT PULL-OUT AREA. HOLD CLEAR OF

BE REMOVED. TIGHTEN THE FLOOR ANCHOR TO THE

ANCHORS AT EACH STEEL HOST ENCLOSURE FRAME.

POUNDS TOTAL LOAD FASTENED TO FRONT RAILS ONLY.

PROVIDE SEISMIC BRACKET MRK-Z4 SERIES INSTALLED TIGHT AT EACH CORNER OF THE STEEL HOST ENCLOSURE FRAME. THE

LEVELING FOOT RIV-NUT IN THE CORNER OF THE FRAME SHALL NOT

MANUFACTURER'S SPECIFIED TORQUE. DEFLECTION WILL OCCUR

PROVIDE 2 EACH 3/8 INCH ITW RAMSET/RED HEAD TRUBOLT WEDGE ANCHOR WITH MINIMUM 2-INCH EMBEDMENT. PROVIDE TOTAL OF 8

ASSUMED LOAD CENTROID FOR AV/IT ELECTRONICS. ALLOW 300

ASSUMED LOAD CENTROID FOR UNINTERRUPTIBLE POWER SYSTEM ALLOW 400 POUNDS TOTAL LOAD FASTENED TO BOTH FRONT AND

AROUND THE RIV-NUT, THIS IS REQUIRED; IT PRE-LOADS THE

AT EACH CORNER OF THE STEEL HOST ENCLOSURE FRAME,

OF ANY OBSTRUCTIONS OR INTRUSIONS.

FASTENING DETAILS.


OBSTRUCTIONS.

REAR RAILS.

CORNER IN COMPRESSION.

(TN2) NOT USED.

CONTRA COSTA COLLEGE

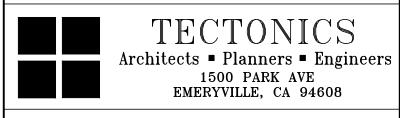



SEALS AND SIGNATURES

**ISSUE SCHEDULE** NO. DATE PLAN REVIEW SUBMITTAL V1 12/30/2020 PLAN REVIEW SUBMITTAL V2 02/03/202

**KEY PLAN** 

PROJECT TRUE NORTH

CONSTRUCTION DOCUMENTS

LOS MEDANOS COLLEGE

COMMUNITY ROOM & CONFERENCE ROOM AV UPGRADES

SHEET TITLE:

DETAILS - RACK R33 FOUR POST

AS SHOWN PROJECT NUMBER: 01-119293

TA903 <sup>197</sup>/<sub>2</sub>

SHEET NUMBER: